LIST OF DRAWINGS & DETAILS					
T-100.00	TITLE SHEET	A-309.00	FLASHING AT CORNICE HEIGHT		
T-101.00	DOB NOTES		TRANSITION DETAIL		
A-100.00	OVERALL ROOF PLAN	A-310.00	STANDING SEAM METAL CLADDING DETAILS		
A-101.00	167 W. 81ST ST. ROOF PLAN	A-311.00	SCUPPER DRAIN DETAIL A		
A-102.00	169 W. 81ST ST. ROOF PLAN	A-312.00	SCUPPER DRAIN DETAIL B		
A-103.00	171 W. 81ST ST. ROOF PLAN	A-313.00	TOP-MOUNTED GUARD RAIL		
A-104.00	173 W. 81ST ST. ROOF PLAN		INSTALLATION		
A-105.00	175 W. 81ST ST. ROOF PLAN	A-314.00	SIDE-MOUNTED RAIL INSTALLATION		
A-300.00	ISO ROOF ASSEMBLY DETAIL	A-315.00	DOOR SADDLE DETAIL		
A-301.00	BASE FLASHING AT STUB WALL	A-316.00	BONDED MASONRY STUB WALL		
A-302.00	THROUGH-WALL BASE FLASHING AT PARTY WALL	A-317.00	FULL HEIGHT PARAPET RECONSTRUCTION		
A-303.00	INSIDE CORNER DETAIL	A-318.00	PARAPET RECONSTRUCTION		
A-304.00	OUTSIDE CORNER DETAIL		WITH RAILING		
A-305.00	PIPE PENETRATION DETAIL	A-319.00	MASONRY AND POINTING DETAIL		
A-306.00	FLASHING AT PIPE PENETRATION DETAIL	A-320.00	LADDER ANCHORAGE DETAIL		
A-307.00	ROOF CURB DETAIL AT	A-321.00	SHEET METAL COPING DETAIL		
	BULKHEAD	A-322.00	WOOD FRAMING DETAILS A		
A-308.00	GRAVEL STOP DETAIL AT BULKHEAD	A-323.00	WOOD FRAMING DETAILS B		

LEGE	LEGEND FOR DRAWINGS					
	ROOF REPLACEMENT WITH INSULATION	0	VENT PIPE			
	LIQUID FLASHING INSTALLATION		REPLACE EXHAUST VENT.			
	GRAVEL STOP INSTALLATION	\bigcirc	INSTALL NEW CURB.			
	NON-FUNCTION MASONRY CHIMNEY REMOVAL		METAL COPING			
	PARAPET STUB WALL REPLACEMENT	~~~	METAL CLADDING INSTALLATION			
	PARAPET STUB WALL REPLACEMENT AT PARTY WALL		SNOW GUARD INSTALLATION AT PEDIMENT			
	PARAPET REPLACEMENT WITH TERRA COTTA COPING SCUPPER DRAIN AND LEADER		DOOR TO BE REMOVED AND REPLACED. RAISE CURB HEIGHT.			

167-175 WEST 81ST STREET IS NOT LOCATED IN "SPECIAL FLOOD HAZARD AREA".

LIST OF CONTROLLED INSPECTIONS:


- 1. FINAL INSPECTION (DIRECTIVE 14 OF 1975)
- 2. ENERGY CODE COMPLIANCE INSPECTIONS AIR SEALING AND INSULATION VISUAL
- 3. SPECIAL INSPECTIONS: MASONRY

POST INSTALLED ANCHORS

OWNER SHALL RETAIN A NYS LICENSED ENGINEER/APPROVED AGENCY TO PROVIDE ALL CONTROLLED/SPECIAL INSPECTIONS.


ENERGY CODE REQUIREMENTS:

1. TO THE BEST OF MY KNOWLEDGE, BELIEF AND PROFESSIONAL JUDGEMENT, THIS APPLICATION IS IN COMPLIANCE WITH THE NYCECC, 2016.

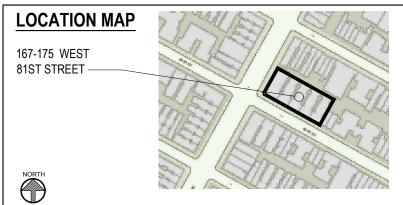

	NYCECC-2016	TABULAR ANALYSIS:		
	WORK ITEMS: INCLUDING NEW AND/OR REPLACEMENT	PROPOSED DESIGN VALUES	CODE PRESCRIBED VALUE & CITATION	
	ENVELOPE	N/A	N/A 502.1 & 502.3 (EXCEPTION)	
	OTHER NOTE	INTERIOR INSULATED CAVITY NOT EXPOSED		

BUILDING CLASSIFICATION: MIXED USE/COMMERCIAL CONSTRUCTION CLASSIFICATION: 3: NON-FIREPROOF STRUCTURES MULTIPLE DWELLING CLASSIFICATION: N/A

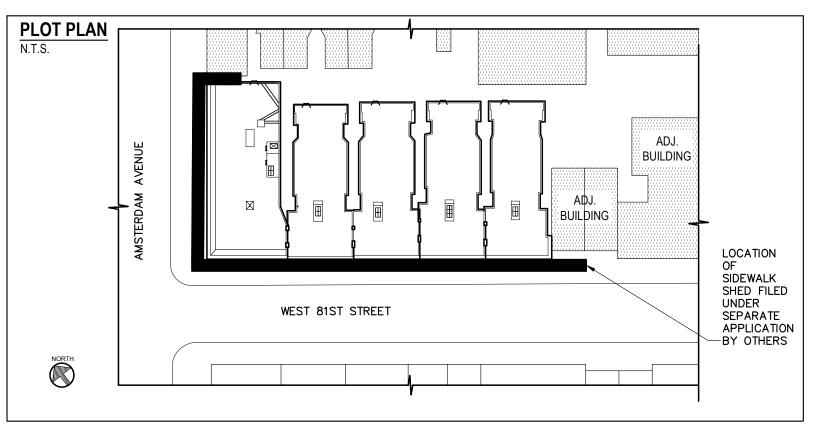

SURFACEDESIGN

40 WORTH STREET **SUITE 814** NEW YORK, NY 10013 TEL: 212.757.5659

DRAWINGS	ISSUED: NOVEMBER 2017
DATE	REVISION
DDO IECT N	AN4E.

PROJECT NAME:

167-175 WEST 81 STREET NEW YORK, NY 10024

TITLE PAGE

ORIG. 167-175 WEST 81ST/ DWGS

1 of 32

PROJECT NO .: 43902-17

DRAWING NO.:

T-100.00

DOB NOTES:

- 1. SCOPE OF WORK: ROOF REPLACEMENT
- ALL WORK SHALL CONFORM TO THE REQUIREMENTS OF THE NEW YORK CITY BUILDING CODE, FIRE DEPARTMENT REGULATIONS, UTILITY COMPANY REQUIREMENTS, AND THE BEST TRADE PRACTICES.
- 3. BEFORE COMMENCING WORK, THE CONTRACTOR SHALL FILE ALL REQUIRED CERTIFICATES OF INSURANCE WITH THE DEPARTMENT OF BUILDINGS, OBTAIN ALL REQUIRED PERMITS, AND PAY ALL FEES REQUIRED BY GOVERNING NEW YORK CITY AGENCIES.
- 4. THE CONTRACTOR SHALL VERIFY ALL EXISTING CONDITIONS IN THE FIELD PRIOR TO COMMENCING WORK, AND SHALL REPORT ANY DISCREPANCIES BETWEEN DRAWINGS AND FIELD CONDITIONS TO THE ARCHITECT.
- 5. MINOR DETAILS NOT USUALLY SHOWN OR SPECIFIED, BUT NECESSARY FOR PROPER CONSTRUCTION OF ANY PART OF THE WORK SHALL BE INCLUDED AS IF THEY WERE INDICATED IN THE DRAWINGS.
- 6. DRAWINGS SHALL NOT BE SCALED; ONLY WRITTEN DIMENSIONS SHALL BE UTILIZED AND ALL DIMENSIONS VERIFIED IN FIELD.
- 7. THE CONTRACTOR SHALL COORDINATE ALL WORK PROCEDURES WITH REQUIREMENTS OF LOCAL AUTHORITIES, BUILDING MANAGEMENT, OR BOARD OF DIRECTORS/MANAGERS, OR OWNER.

- 8. THE CONTRACTOR SHALL BE RESPONSIBLE FOR THE PROTECTION OF ALL CONDITIONS AND MATERIALS WITHIN THE PROPOSED CONSTRUCTION AREA. THE CONTRACTOR SHALL DESIGN AND INSTALL ADEQUATE SHORING AND BRACING FOR ALL STRUCTURAL OR REMOVAL TASKS. THE CONTRACTOR SHALL HAVE SOLE RESPONSIBILITY FOR ANY DAMAGE OR INJURIES CAUSED BY OR DURING THE EXECUTION OF THE WORK.
- 9. THE CONTRACTOR SHALL LAY OUT HIS OWN WORK, AND SHALL PROVIDE ALL DIMENSIONS REQUIRED FOR OTHER TRADES: PLUMBING, ELECTRICAL, ETC.
- 10. PLUMBING AND ELECTRICAL WORK SHALL BE PERFORMED BY PERSONS LICENSED IN THEIR TRADE, WHO SHALL ARRANGE FOR AND OBTAIN INSPECTIONS AND REQUIRED SIGN-OFFS.
- 11. THE CONTRACTOR SHALL DO ALL CUTTING, PATCHING, REPAIRING AS REQUIRED TO PERFORM ALL THE WORK INDICATED ON THE DRAWINGS, AND ALL OTHER WORK THAT MAY BE REQUIRED TO COMPLETE THE JOB.
- 12. CONTRACTOR SHALL REMOVE CONSTRUCTION DEBRIS ON A DAILY BASIS AND LEAVE AREA BROOM CLEAN.
- 13. THE ARCHITECT HAS NOT BEEN RETAINED TO PROVIDE SUPERVISION.
- 14. THE OWNER IS REQUIRED TO COMPLY WITH SECTION BC-3309 FORM 1-16 ON PROTECTION OF ADJOINING PROPERTY.

2014 BUILDING CODE TENANT PROTECTION PLAN NOTES:

ALL WORK SHALL COMPLY WITH SECTION 28-104.8.4 OF THE 2014 BUILDING CODE AS SUMMARIZED BELOW:

- GENERAL: CONSTRUCTION DOCUMENTS FOR ALTERATIONS OF BUILDINGS IN WHICH ANY DWELLING UNIT WILL BE OCCUPIED DURING CONSTRUCTION SHALL INCLUDE A TENANT PROTECTION PLAN WITH SPECIFIC DETAILS THE DESCRIBE THE MEANS AND METHODS TO SAFEGUARD THE SAFETY AND HEALTH OF THE OCCUPANTS.
- EGRESS: CONTRACTOR SHALL AT ALL TIMES IN THE COURSE OF CONSTRUCTION, PROVISION SHALL BE MADE FOR
 ADEQUATE EGRESS AS REQUIRED BY THIS CODE AND THE TENANT PROTECTION PLAN SHALL IDENTIFY THE EGRESS
 THAT WILL BE PROVIDED. REQUIRED EGRESS SHALL NOT BE OBSTRUCTED AT ANY TIME EXCEPT WHERE APPROVED BY
 THE COMMISSIONER.
- 3. FIRE SAFETY: CONTRACTOR SHALL COMPLY WITH ALL NECESSARY LAWS AND CONTROLS, INCLUDING THOSE WITH OCCUPIED DWELLINGS, AS WELL AS ADDITIONAL SAFETY MEASURES NECESSITATED BY THE CONSTRUCTION SHALL BE STRICTLY OBSERVED AND INCLUDE BUT ARE NOT LIMITED TO THE FOLLOWING:
 - A) ALL BUILDING MATERIALS STORED AT CONSTRUCTION AREA, AND/OR IN ANY AREA OF THE WORKSITE ARE TO BE SECURED IN A LOCKED AREA. ACCESS TO SUCH AREAS ARE TO BE CONTROLLED BY OWNER/GENERAL CONTRACTOR.

 B) ALL MATERIALS ARE TO BE STORED IN AN ORDERLY FASHION.
 - C) ALL FLAMMABLE MATERIALS TO BE KEPT TIGHTLY SEALED IN THEIR RESPECTIVE MANUFACTURERS CONTAINERS AND SUCH CONTAINERS ARE TO BE KEPT AWAY FROM HEAT.
 - D) ALL FLAMMABLE MATERIALS ARE TO BE USED AND STORED IN AN ADEQUATELY VENTILATED SPACE.
 - E) ALL ELECTRICAL POWER TO BE SHUT OFF WHERE THERE IS EXPOSED CONDUIT.
- F) ALL ELECTRICAL POWER TO THE WORK SITE IS TO BE SHUT OFF AFTER WORKING HOURS.
- 4. CONTRACTOR SHALL COMPLY WITH THE FOLLOWING HEALTH REQUIREMENTS:
- A) DEBRIS, DIRT AND DUST TO BE KEPT TO A MINIMUM AND CONFINED TO IMMEDIATE CONSTRUCTION AREA.
- B) CONTRACTOR TO ISOLATE CONSTRUCTION AREA FROM OCCUPIED BUILDING AREA BY MEANS OF HEAVY WEIGHT DROP CLOTHS.
- C) DEBRIS, DIRT, AND DUST TO BE CLEANED UP AND CLEANED FROM WORK SITE PERIODICALLY TO AVOID EXCESSIVE ACCUMULATION AS REQUIRED BY THE HOUSEKEEPING REGULATIONS OF THE SITE SAFETY MANUAL.
- CONTRACTOR SHALL COMPLY WITH HOUSING STANDARDS: THE REQUIREMENTS OF THE NEW YORK CITY HOUSING MAINTENANCE CODE, AND, WHERE APPLICABLE, THE NEW YORK STATE MULTIPLE DWELLING LAW SHALL BE STRICTLY OBSERVED.
- 6. STRUCTURAL SAFETY: NO STRUCTURAL WORK SHALL BE PERFORMED BY THE CONTRACTOR THAT MAY ENDANGER THE OCCUPANTS.
- 7. NOISE CONTROL:
 - A) CONSTRUCTION OPERATIONS WILL BE CONFINED TO NORMAL WORKING HOURS: 7:00 A.M. TO 6:00 P.M., MONDAY TO FRIDAY EXCEPT LEGAL HOLIDAYS.
 - B) CONTRACTOR TO OBTAIN WRITTEN CONSENT OF ALL PARTIES AFFECTED BY HIS WORKING DURING OTHER THAN NORMAL WORKING HOURS.
 - C) CONTRACTOR SHALL OBTAIN AFTER HOUR WORK PERMIT FROM THE DEPARTMENT OF BUILDINGS AND APPLICABLE AGENCIES IF WORKING OTHER THAN NORMAL WORKING HOURS.
- 8. CONTRACTOR'S CONSTRUCTION OPERATIONS WILL NOT INVOLVE INTERRUPTION OF HEATING, WATER, OR ELECTRICAL SERVICES TO TENANTS OF BUILDING.
- CONTRACTOR'S CONSTRUCTION WORK WILL BE CONFINED TO AREAS OF WORK DETAILED ON THIS PLAN AND WILL NOT CREATE DUST, DIRT, DEBRIS OR SUCH INCONVENIENCES TO OTHER RESIDENTIAL AREAS OF THE BUILDING.
- 10. CONTRACTOR SHALL NOT PERMIT ACCESS TO THE WORK SITE AREAS BY TENANTS OR THE PUBLIC DURING CONSTRUCTION OPERATIONS UNLESS OTHERWISE ALLOWED BY THE BUILDING OWNER.

2016 ENERGY CODE BUILDING ENVELOPE REQUIREMENTS:

402.1.1 INSULATION AND FENESTRATION CRITERIA

1. THE BUILDING THERMAL ENVELOPE SHALL MEET THE REQUIREMENTS OF TABLES C402.2 AND C402.3 BASED ON THE CLIMATE ZONE SPECIFIED IN CHAPTER 3. COMMERCIAL BUILDINGS OR PORTIONS OF COMMERCIAL BUILDINGS ENCLOSING GROUP R OCCUPANCIES SHALL USE THE R-VALUES FROM THE "GROUP R" COLUMN OF TABLE C402.2. COMMERCIAL BUILDINGS OR PORTIONS OF COMMERCIAL ENCLOSING OTHER THAN GROUP R SHALL USE THE R-VALUES FROM THE "ALL OTHER" COLUMN OF TABLE C402.2. BUILDINGS WITH A VERTICAL FENESTRATION AREA OR SKYLIGHT AREA THAT EXCEEDS THAT ALLOWED IN TABLE C402.3 SHALL COMPLY WITH THE BUILDING ENVELOPE PROVISIONS OF ASHRAE/IESNA 90.1.-2010, AS AMENDED BY APPENDIX A OF THE NEW YORK CITY ENERGY CONSERVATION CODE.

402.1.2 U-FACTOR ALTERNATIVE

1. AN ASSEMBLY WITH A U-FACTOR, C-FACTOR, OR F-FACTOR EQUAL TO OR LESS THAN THAT SPECIFIED IN TABLE C402.1.2 SHALL BE PERMITTED AS AN ALTERNATIVE TO THE R-VALUE IN TABLE C402.2. COMMERCIAL BUILDINGS OR PORTIONS OF COMMERCIAL BUILDINGS ENCLOSING GROUP R OCCUPANCIES SHALL USE THE U-FACTOR, C-FACTOR, OR F-FACTOR FROM THE "GROUP R" COLUMN OF TABLE C402.1.2. COMMERCIAL BUILDINGS OR PORTIONS OF COMMERCIAL BUILDINGS ENCLOSING OCCUPANCIES OTHER THAN GROUP R SHALL USE THE U-FACTOR, C-FACTOR OR F-FACTOR FROM THE "ALL OTHER" COLUMN OF TABLE C402.1.2.

402.3 FENESTRATION

1. FENESTRATION SHALL COMPLY WITH TABLE C402.3.

402.3.1 MAXIMUM AREA

1. THE VERTICAL FENESTRATION AREA (NOT INCLUDING OPAQUE DOORS AND OPAQUE SPANDREL PANELS) SHALL NOT EXCEED 30 PERCENT OF THE GROSS ABOVE-GRADE WALL AREA. THE SKYLIGHT AREA SHALL NOT EXCEED 3 PERCENT OF THE GROSS ROOF AREA.

402.3.3 MAXIMUM U-FACTOR AND SHGC

- FOR VERTICAL FENESTRATION, THE MAXIMUM U-FACTOR AND SOLAR HEAT GAIN COEFFICIENT (SHGC) SHALL BE AS SPECIFIED IN TABLE C402.3, BASED ON THE WINDOW PROJECTION FACTOR. FOR SKYLIGHTS, THE MAXIMUM U-FACTOR AND SOLAR HEAT GAIN COEFFICIENT (SHGC) SHALL BE AS SPECIFIED IN TABLE C402.3.
- 2. THE WINDOW PROJECTION FACTOR SHALL BE DETERMINED IN ACCORDANCE WITH EQUATION 4-2, PF = A/B, WHERE :

 A) PF = PROJECTION FACTOR (DECIMAL).
 - B) A = DISTANCE MEASURED HORIZONTALLY FROM THE FURTHEST CONTINUOUS EXTREMITY OF ANY OVERHANG, EAVE, OR PERMANENTLY ATTACHED SHADING DEVICE TO THE VERTICAL SURFACE OF THE GLAZING.
 - C) B = DISTANCE MEASURED VERTICALLY FROM THE BOTTOM OF THE GLAZING TO THE UNDERSIDE OF THE OVERHANG, EAVE, OR PERMANENTLY ATTACHED SHADING DEVICE.
- 3. WHERE DIFFERENT WINDOWS OR GLASS DOORS HAVE DIFFERENT PF-VALUES, THEY SHALL EACH BE EVALUATED SEPARATELY.

SURFACEDESIGN

40 WORTH STREET SUITE 814 NEW YORK, NY 10013 TEL: 212.757.5659

DRAWINGS	ISSUED:	NOVEMBER	2017
DATE	REVISIO	N	

PROJECT NAME:

167 WEST 81 STREET NEW YORK, NY 10024


DOB NOTES

ORIG. 167-175 WEST 81ST/ DWGS

SHEET: PROJECT NO.: 2 of 32 43902-17

DRAWING NO.

T-101.00

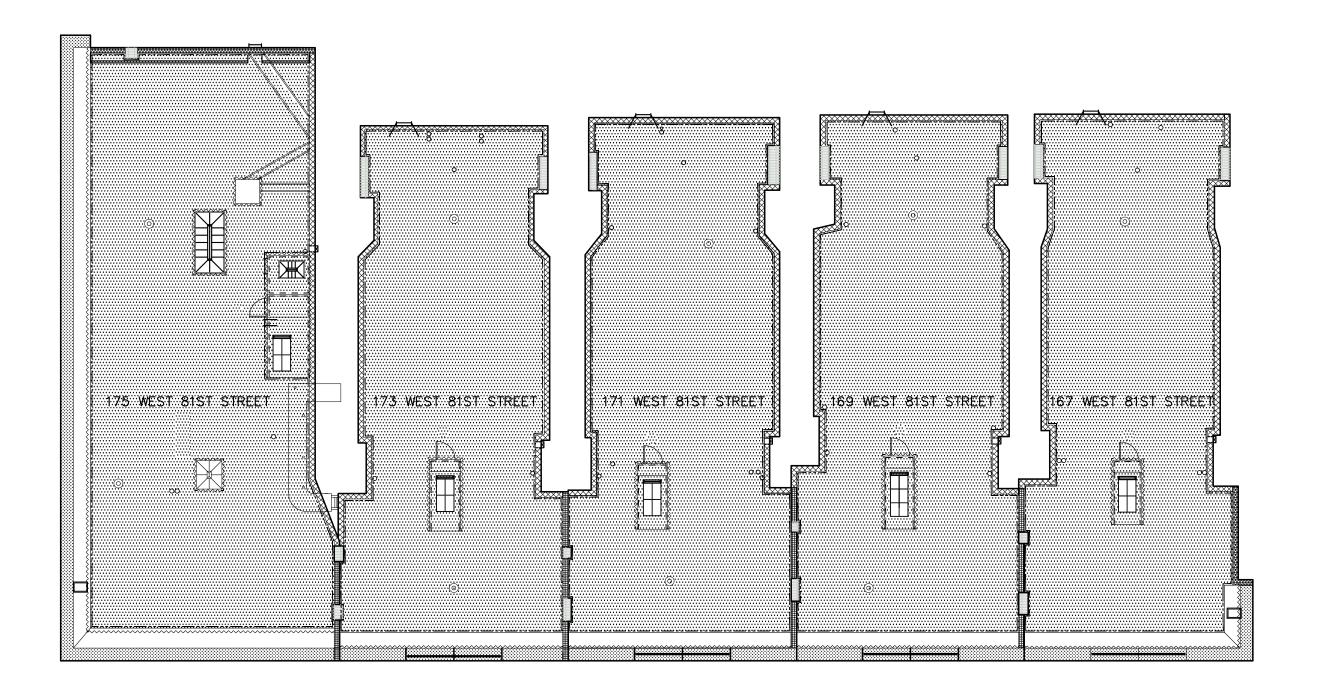

ROOF PLAN

1/16" = 1'-0"



SURFACEDESIGN

40 WORTH STREET SUITE 814 NEW YORK, NY 10013 TEL: 212.757.5659

DRAWINGS	ISSUED: NOVEMBER 2017
DATE	REVISION

PROJECT NAME:

167-175 W 81 STREET NEW YORK, NY 10024

OVERALL ROOF PLAN


ORIG. 167-175W81ST/DWGS

SHEET: 3 of 32

of 32 PROJECT NO.: 43902-17

DRAWING NO.:


A-100.00

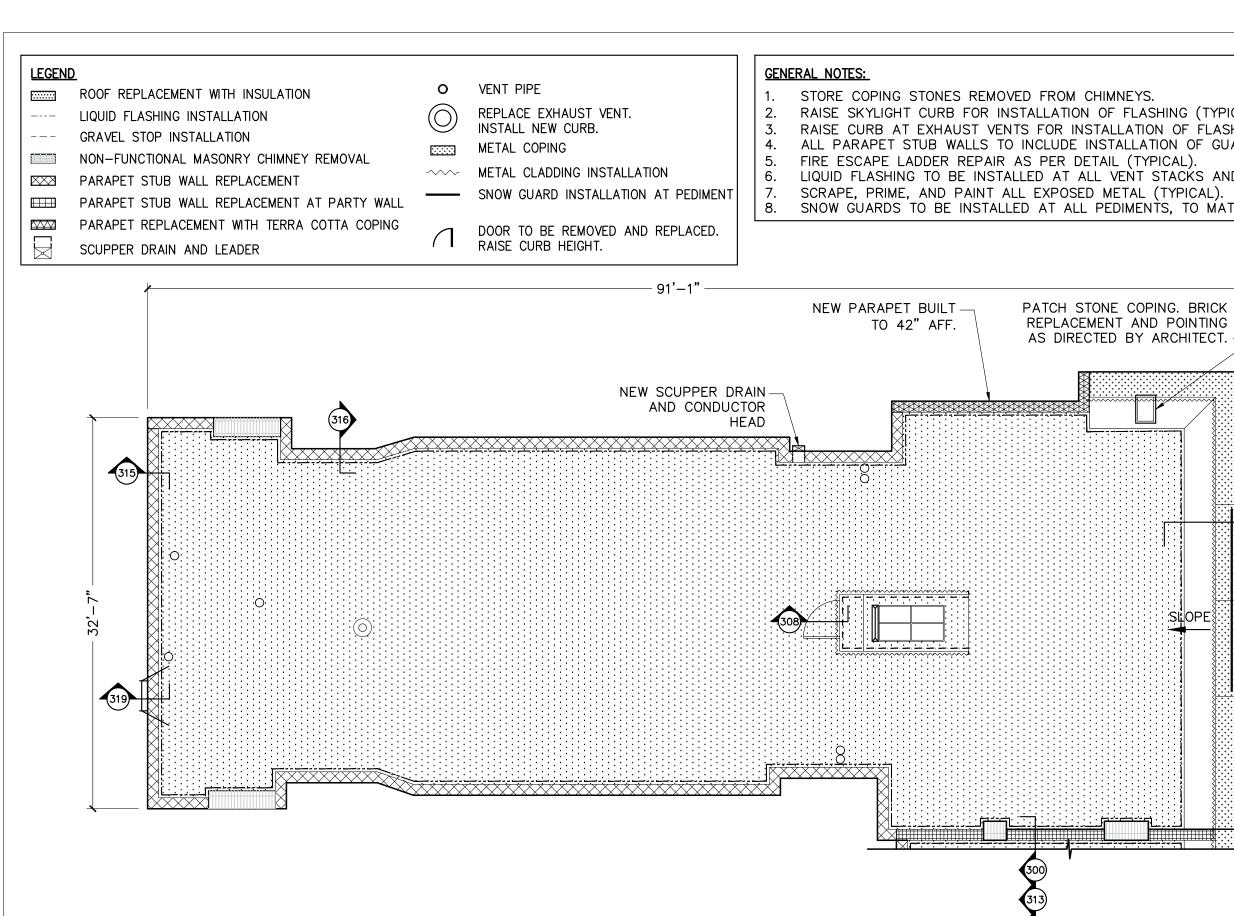

ROOF PLAN

1/8" = 1'-0'

- RAISE SKYLIGHT CURB FOR INSTALLATION OF FLASHING (TYPICAL).
- RAISE CURB AT EXHAUST VENTS FOR INSTALLATION OF FLASHING (TYPICAL).
- ALL PARAPET STUB WALLS TO INCLUDE INSTALLATION OF GUARDRAIL.
- LIQUID FLASHING TO BE INSTALLED AT ALL VENT STACKS AND PENETRATIONS.
- SNOW GUARDS TO BE INSTALLED AT ALL PEDIMENTS, TO MATCH COPING.

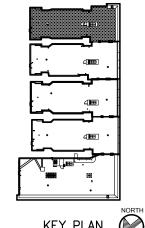

KEY PLAN

SURFACEDESIGN

40 WORTH STREET SUITE 814 NEW YORK, NY 10013 TEL: 212.757.5659

DRAWINGS ISSUED: NOVEMBER 2017 REVISION

PROJECT NAME:

167-175 WEST 81 STREET NEW YORK, NY 10024

167 WEST 81 STREET **ROOF PLAN**


ORIG. 167-175W81ST/DWGS


4 of 32

PROJECT NO .: 43902-17

DRAWING NO .:

A-101.00

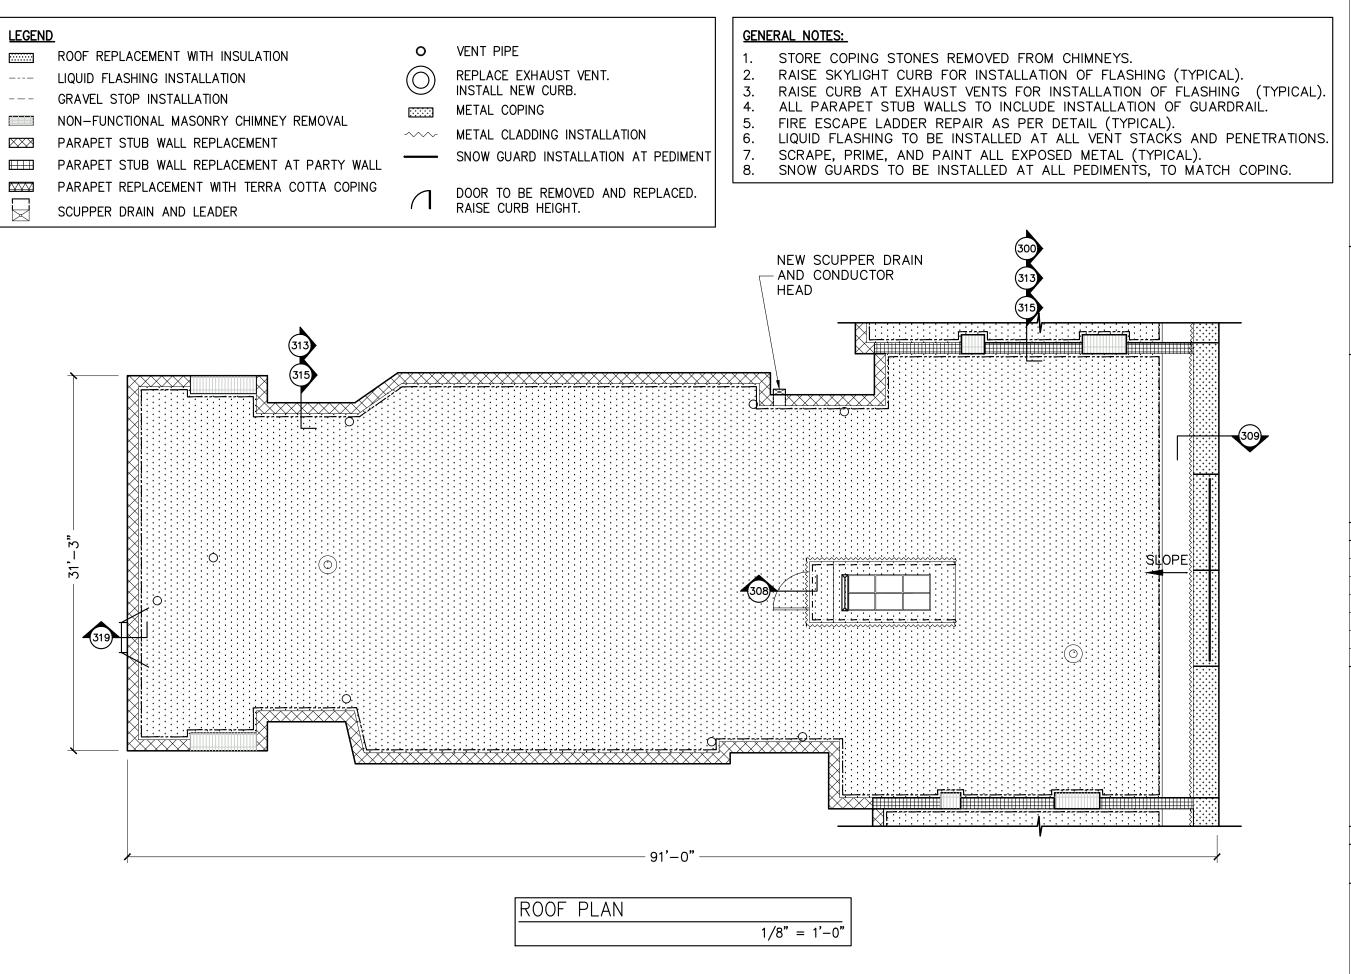

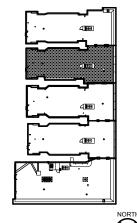

<u>KEY PLAN</u>

SURFACEDESIGN

40 WORTH STREET SUITE 814 NEW YORK, NY 10013 TEL: 212.757.5659

DRAWINGS ISSUED: NOVEMBER 2017

DATE REVISION

PROJECT NAME:

167-175 WEST 81 STREET NEW YORK, NY 10024


169 WEST 81 STREET ROOF PLAN


ORIG. 167-175W81ST/DWGS

SHEET: PROJECT NO.: 5 of 32 43902-17

DRAWING NO.:

A-102.00

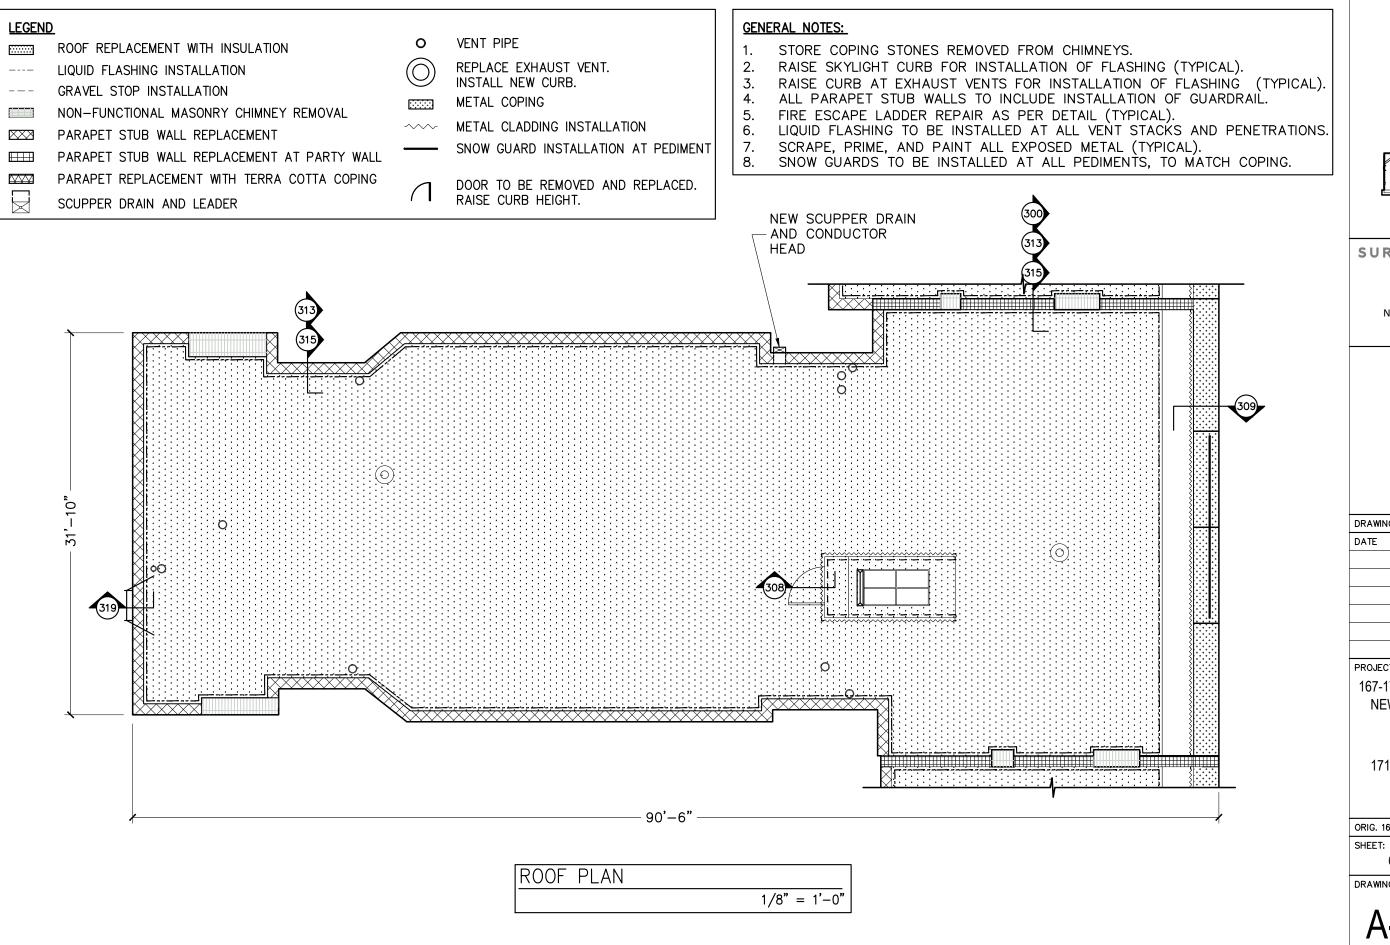

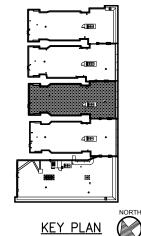

SURFACEDESIGN

40 WORTH STREET SUITE 814 NEW YORK, NY 10013 TEL: 212.757.5659

DRAWINGS ISSUED: NOVEMBER 2017 REVISION

PROJECT NAME:

167-175 WEST 81 STREET NEW YORK, NY 10024

171 WEST 81 STREET **ROOF PLAN**


ORIG. 167-175W81ST/DWGS


6 of 32

PROJECT NO .: 43902-17


DRAWING NO.:

A-103.00

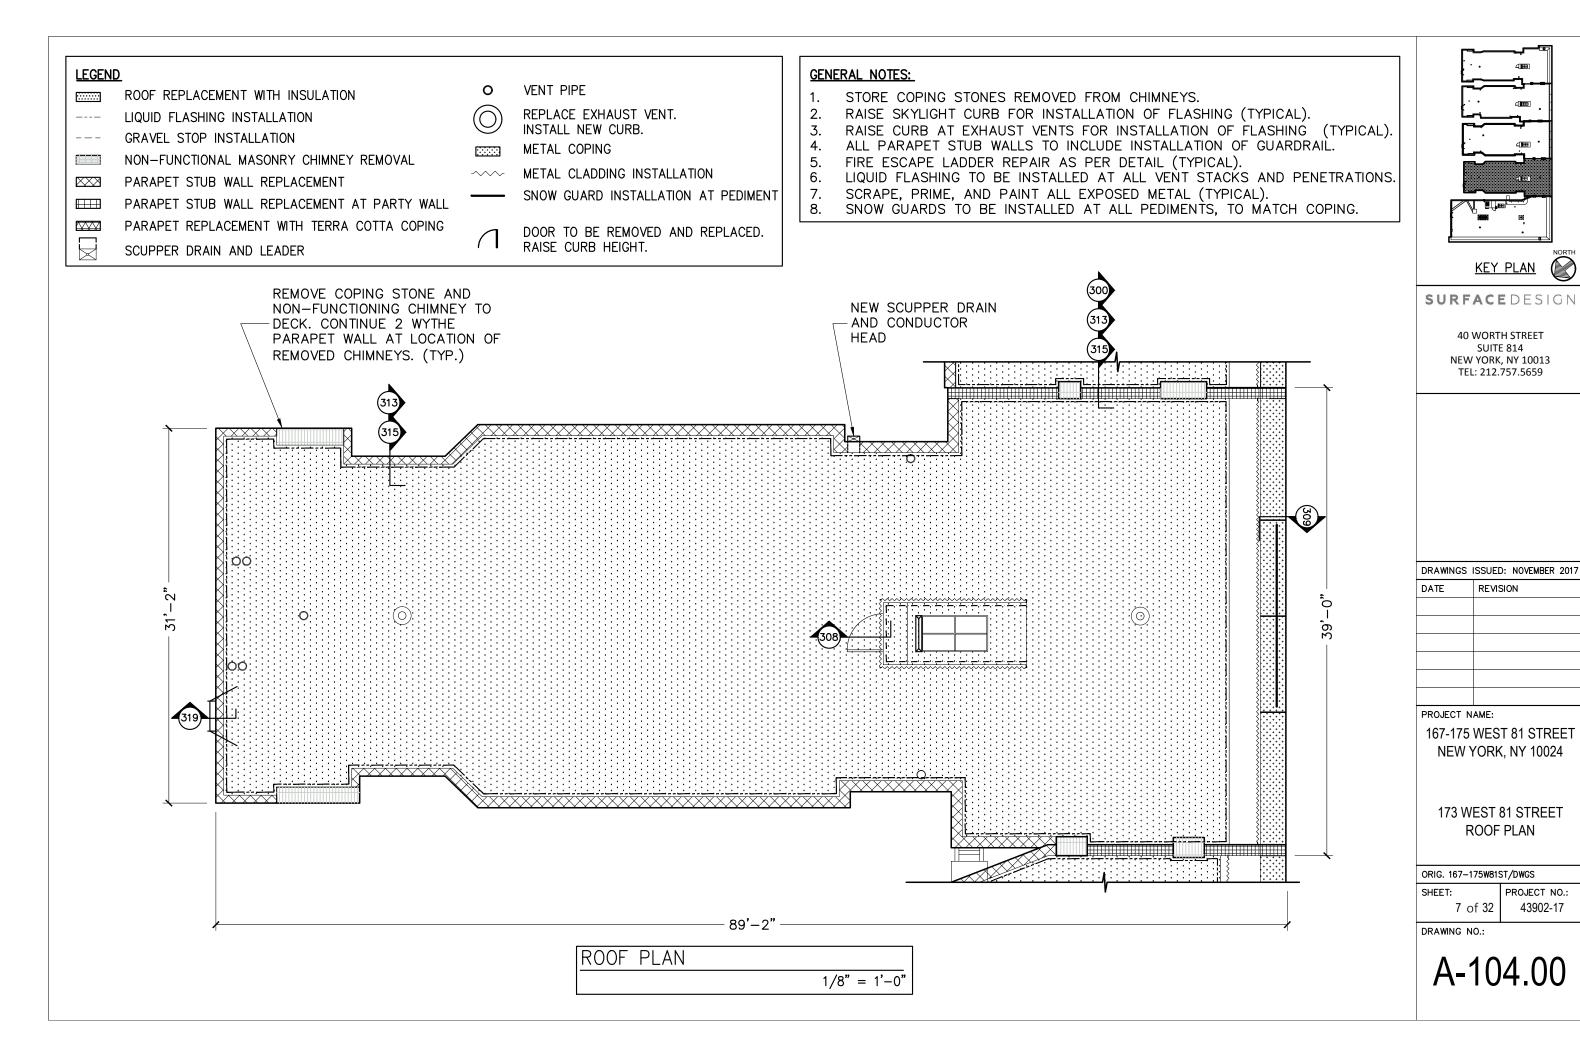

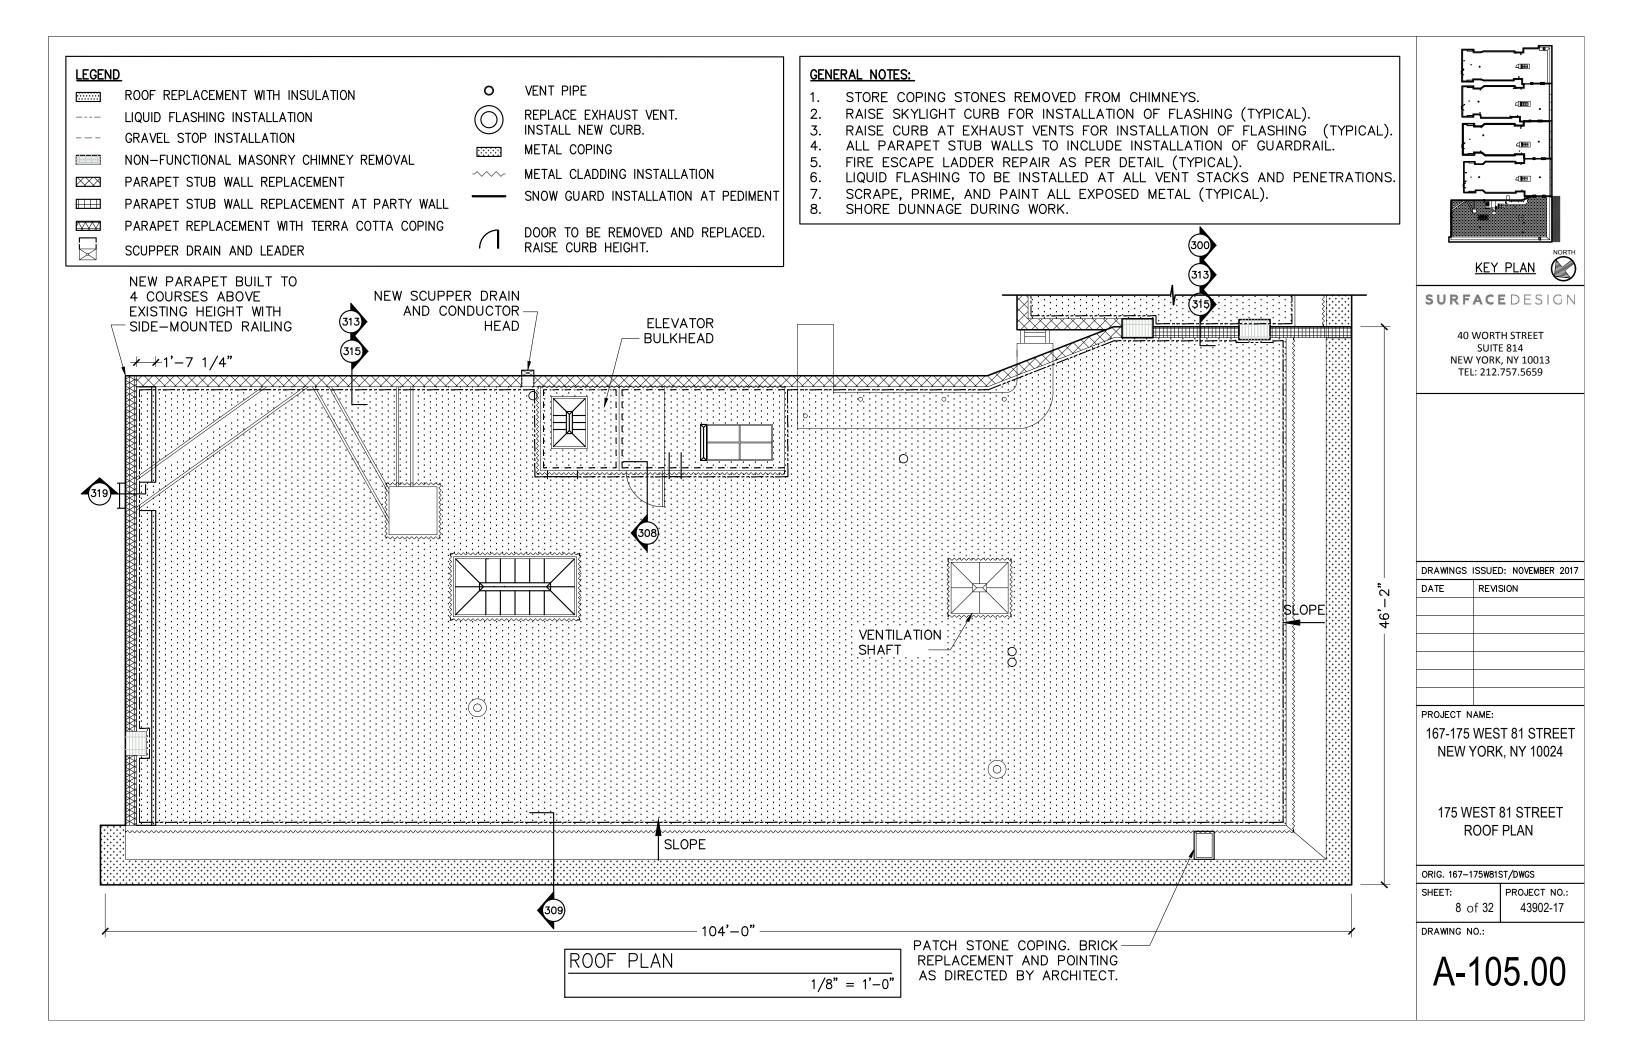

- DETAIL IS SUBJECT TO MODIFICATION DUE TO EXISTING SITE CONDITIONS.
 DETAIL TO BE USED IN CONJUNCTION WITH SOPREMA GENERAL
- REQUIREMENTS, APPLICATION METHODS AND APPROVED DETAILS.
- 3. ARCHITECT SHALL INSPECT ALL WATERPROOFING PRIOR TO MASONRY INSTALLATION.
- 4. EXISTING PARAPET HEIGHTS VARY FROM 1'4" TO 4'0". CONTRACTOR TO RECONSTRUCT NEW PARAPETS TO MINIMUM HEIGHT REQUIRED FOR THE ROOFING SYSTEM AND INSTALLATION OF METAL COPINGS. SEE DETAILS.

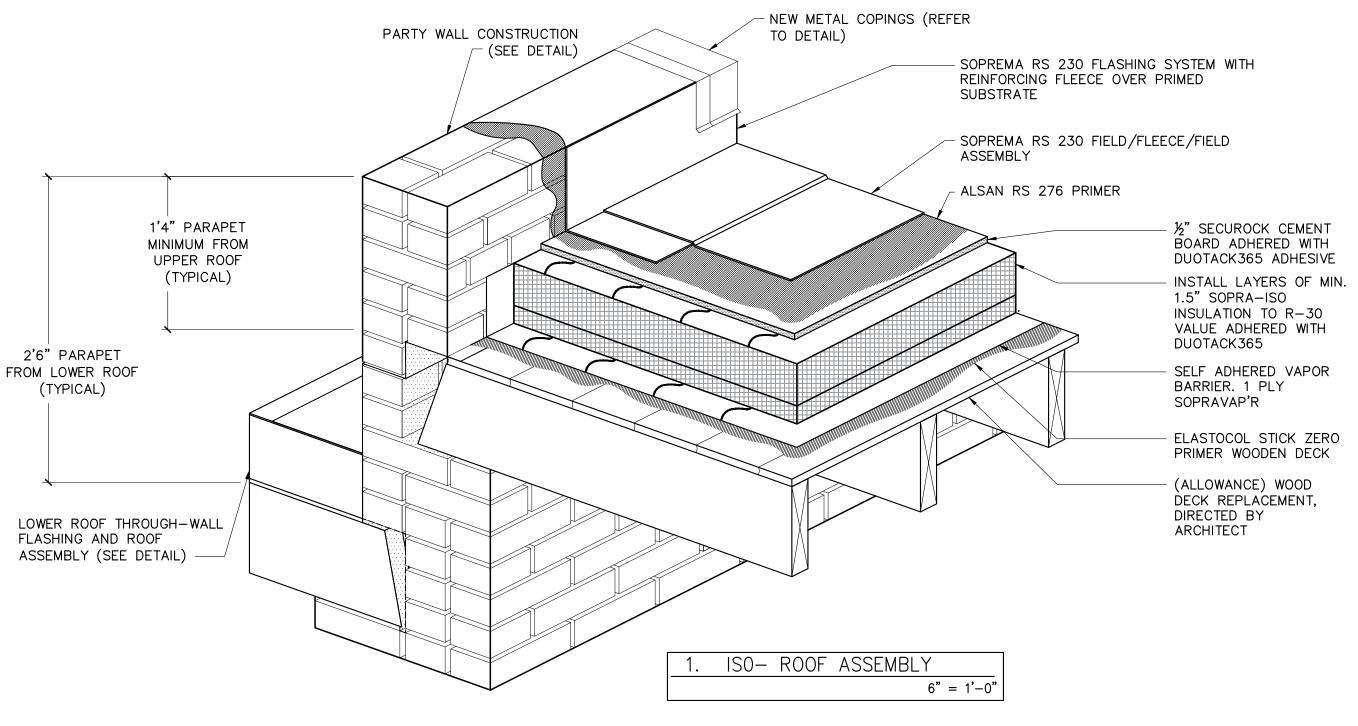

SURFACEDESIGN

40 WORTH STREET SUITE 814 NEW YORK, NY 10013 TEL: 212.757.5659

DRAWINGS ISSUED: NOVEMBER 2017

TE REVISION

CM

PROJECT NAME:

167-175 WEST 81 STREET NEW YORK, NY 10024

> ISOMETRIC ROOF ASSEMBLY DETAIL

ORIG. 167-175W81ST/DWGS


SHEET:

PROJECT NO.: 9 of 32 43902-17

DRAWING NO.:

A-300.00

- 1. DETAIL IS SUBJECT TO MODIFICATION DUE TO EXISTING SITE CONDITIONS.
 2. DETAIL TO BE USED IN CONJUNCTION WITH SOPREMA GENERAL
- REQUIREMENTS, APPLICATION METHODS AND APPROVED DETAILS.
- 3. AT MASONRY STUB WALL, ALSAN FLASHING TO EXTEND UP AND OVER THE MASONRY, AND TIE IN WITH FLASHINGS FOR THE RAILING POSTS.
- 4. ARCHITECT TO INSPECT WATERPROOFING PRIOR TO INSTALLATION OF METAL COPINGS.

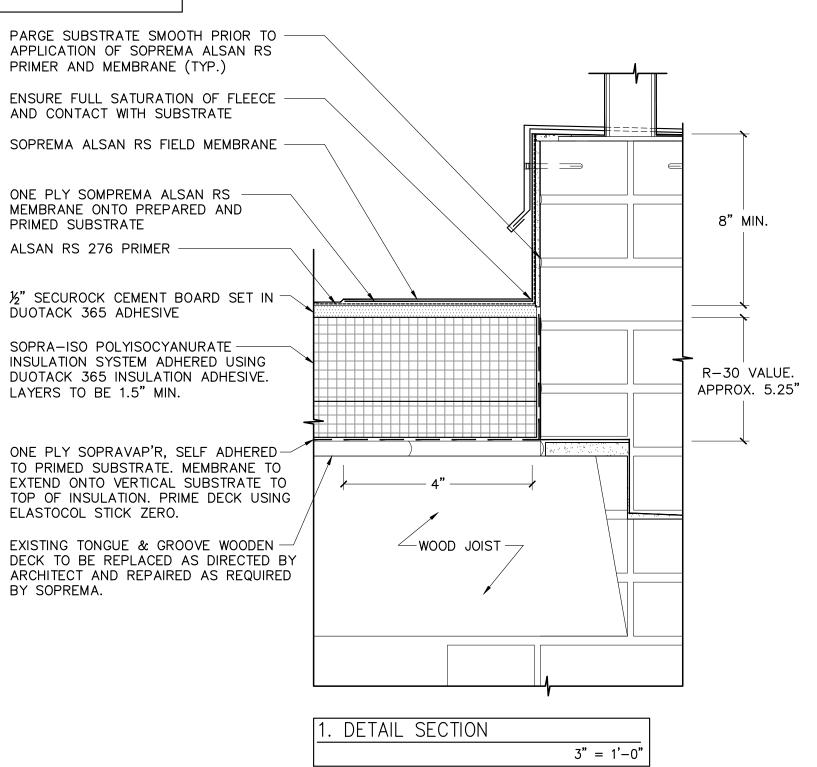

SURFACEDESIGN

40 WORTH STREET SUITE 814 NEW YORK, NY 10013 TEL: 212.757.5659

DRAWINGS ISSUED: NOVEMBER 2017

DATE	REVISION

PROJECT NAME:

167-175 WEST 81 STREET NEW YORK, NY 10024

> BASE FLASHING AT STUB WALL


ORIG. 167-175W81ST/DWGS

SHEE 1:

: PROJECT NO.: 43902-17

DRAWING NO.:

A-301.00

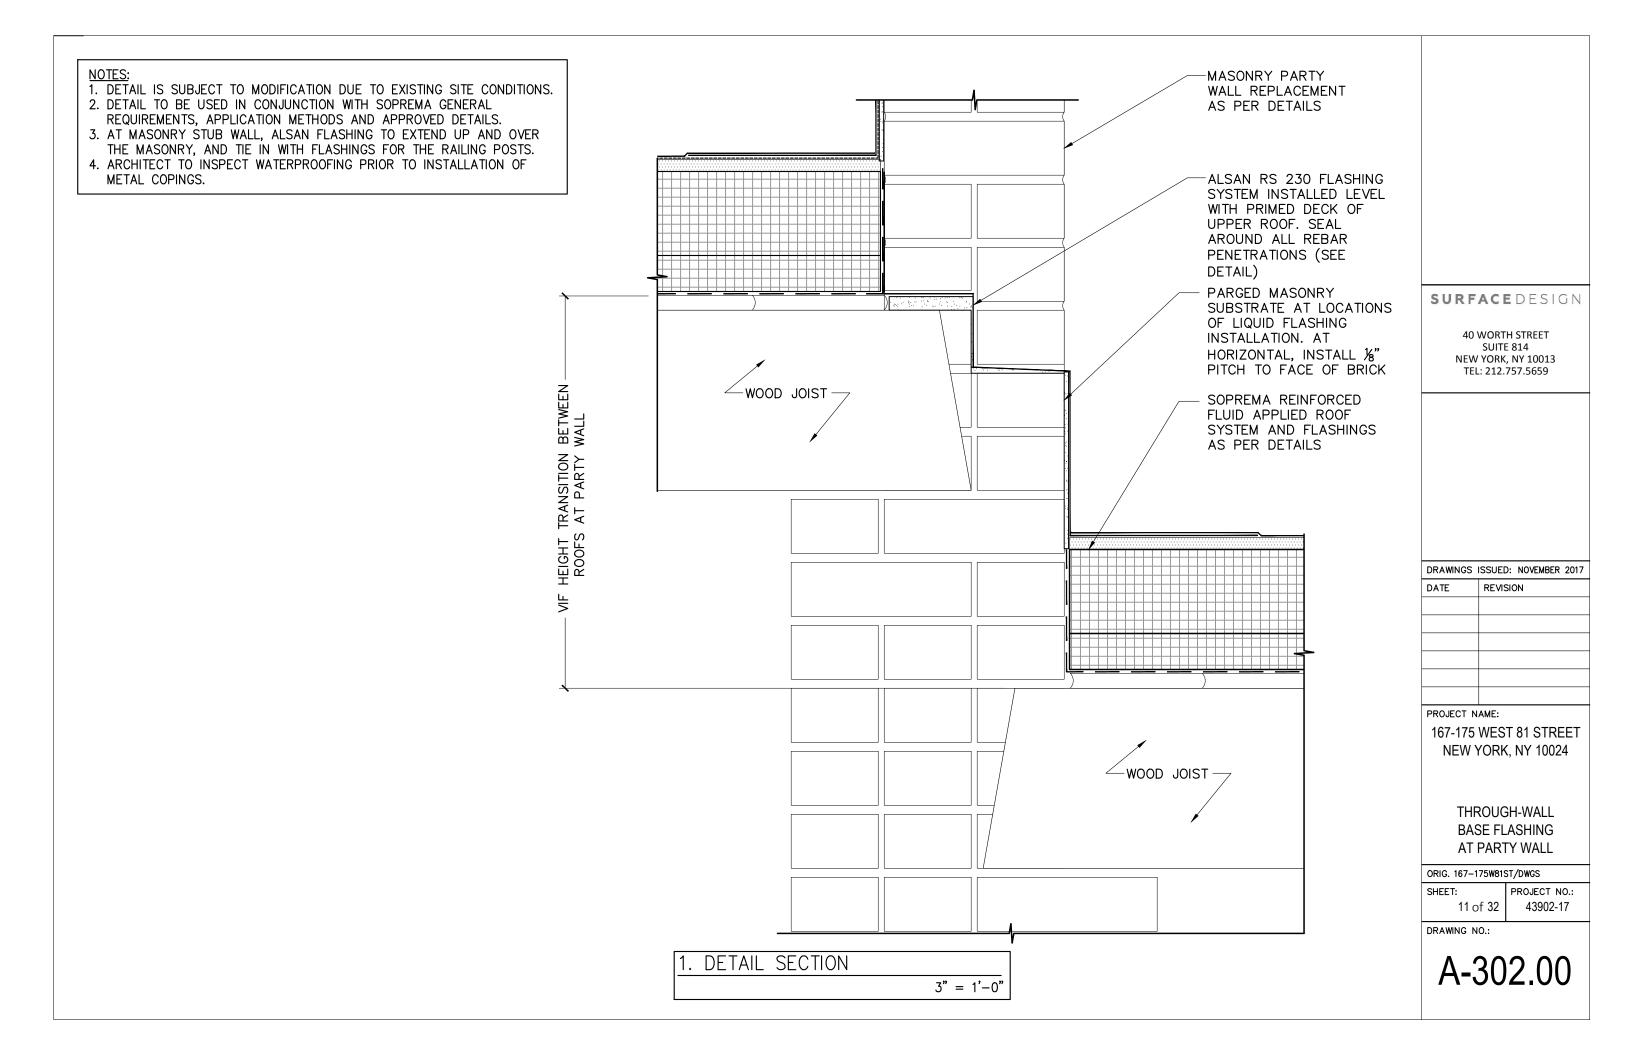





- 1. DETAIL IS SUBJECT TO MODIFICATION DUE TO EXISTING SITE CONDITIONS.
 2. DETAIL TO BE USED IN CONJUNCTION WITH SOPREMA GENERAL
- REQUIREMENTS, APPLICATION METHODS, AND APPROVED DETAILS.

 3. ARCHITECT SHALL INSPECT ALL WATERPROOFING PRIOR TO MASONRY INSTALLATION.

STEP 1: INSIDE CORNER
HANDCUT POLYESTER FLEECE.
PROVIDE 1" MIN. UP TURN.


1

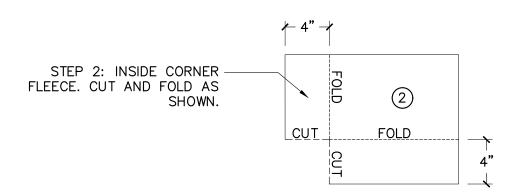

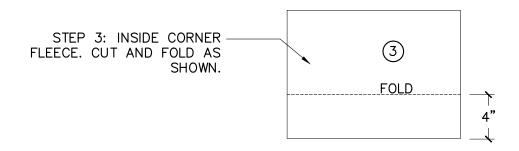

1. INSIDE CORNER DETAIL

NOT TO SCALE FLASHINGS

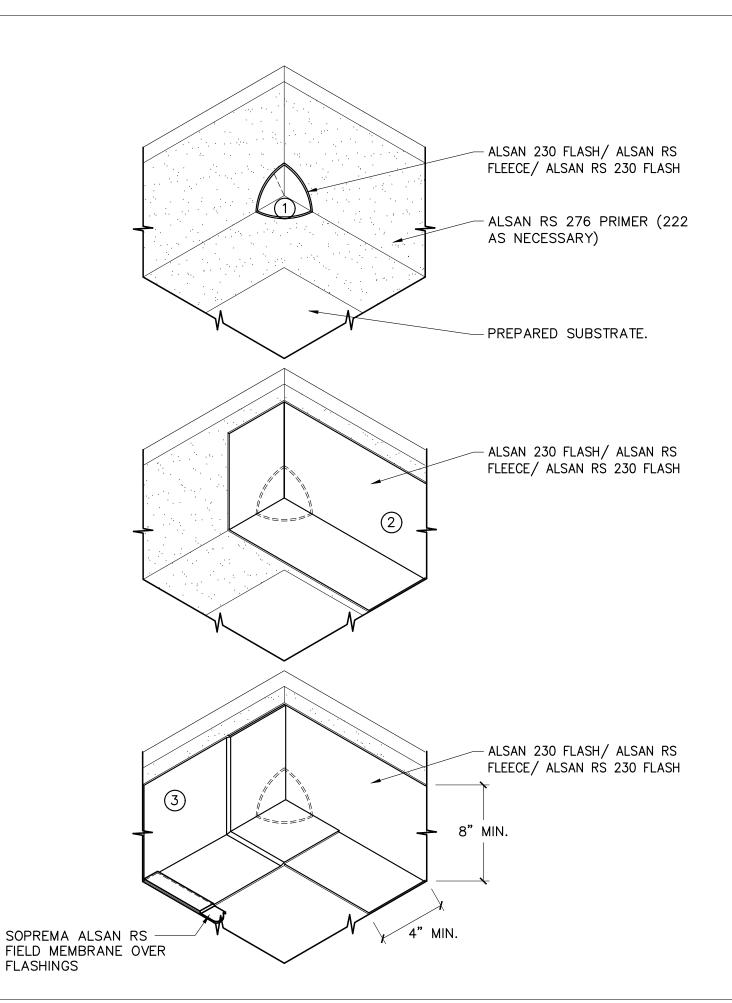

SURFACEDESIGN

40 WORTH STREET SUITE 814 NEW YORK, NY 10013 TEL: 212.757.5659

DRAWINGS ISSUED: NOVEMBER 2017

DATE REVISION

PROJECT NAME:

167-175 WEST 81 STREET NEW YORK, NY 10024

INSIDE CORNER DETAIL


ORIG. 167-175W81ST/DWGS

12 of 32


PROJECT NO.: 43902-17

DRAWING NO.:

A-303.00

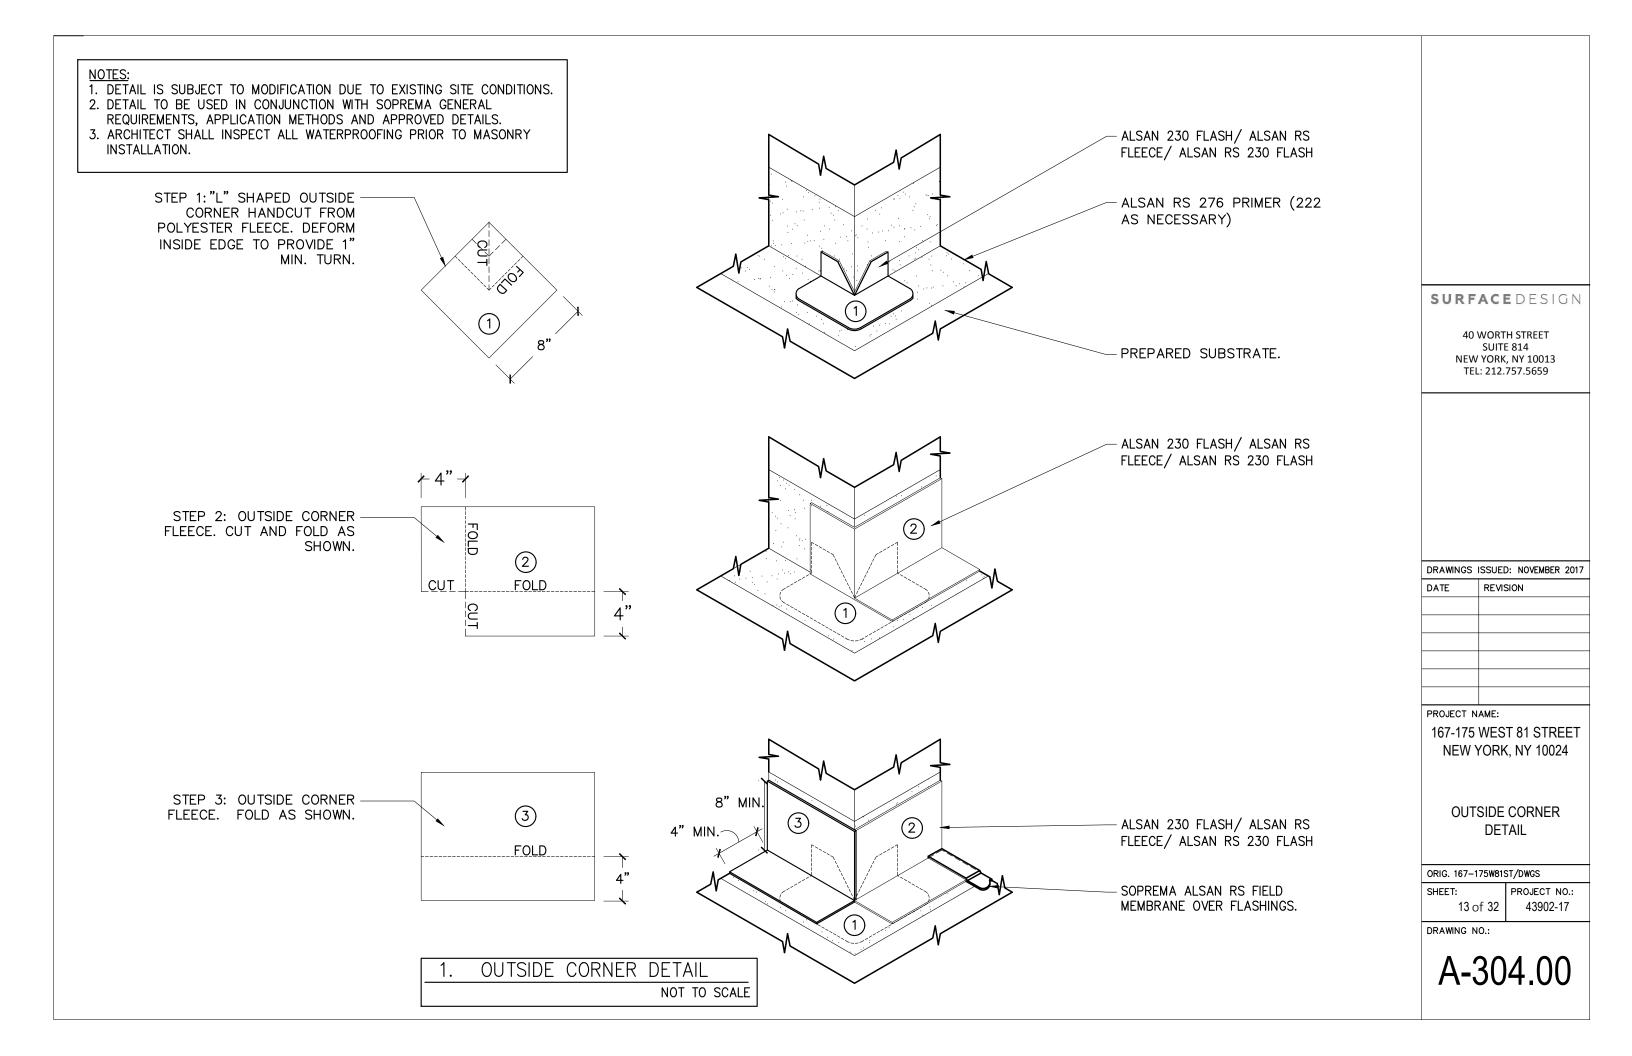

- 1. DETAIL IS SUBJECT TO MODIFICATION DUE TO EXISTING SITE CONDITIONS.
- 2. DETAIL TO BE USED IN CONJUNCTION WITH SOPREMA GENERAL REQUIREMENTS, APPLICATION METHODS, AND APPROVED DETAILS.

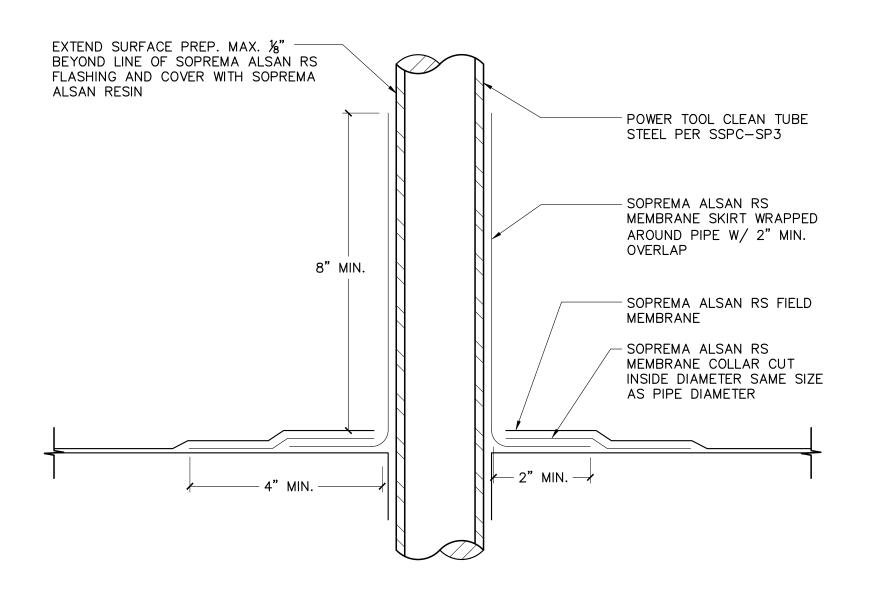

1. DETAIL SECTION

6" = 1'-0"

SURFACEDESIGN

40 WORTH STREET SUITE 814 NEW YORK, NY 10013 TEL: 212.757.5659

DRAWINGS ISSUED: NOVEMBER 2017

DATE REVISION

PROJECT NAME:

167-175 WEST 81 STREET NEW YORK, NY 10024

PIPE PENETRATION DETAIL


ORIG. 167-175W81ST/DWGS

SHEET: 14 of 32

PROJECT NO.: 43902-17

DRAWING NO.:

A-305.00

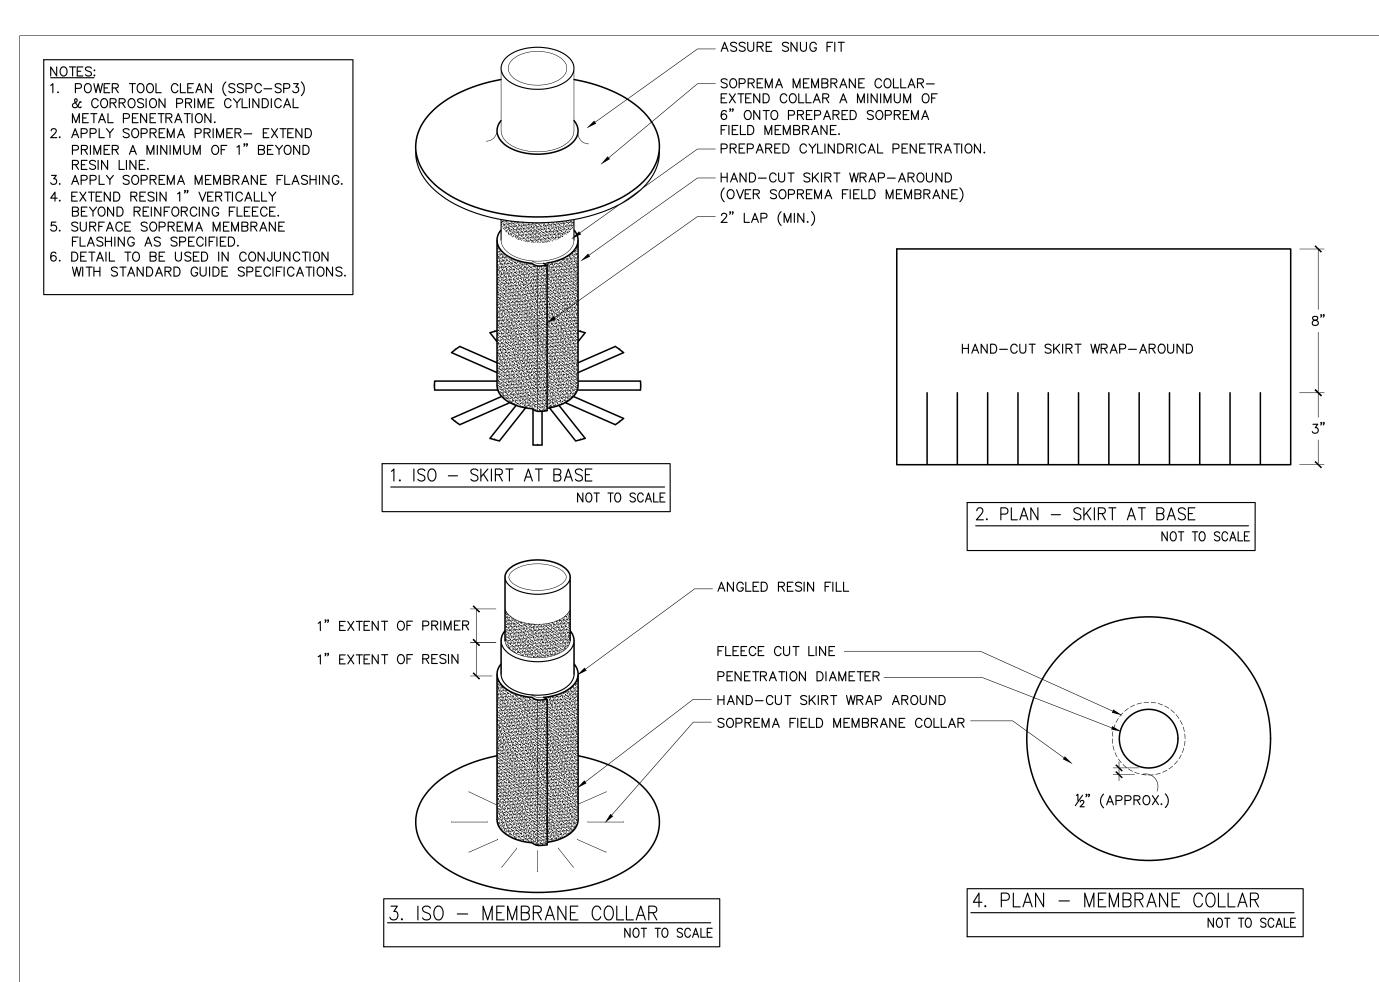

SURFACEDESIGN

40 WORTH STREET SUITE 814 NEW YORK, NY 10013 TEL: 212.757.5659

DRAWINGS ISSUED: NOVEMBER 2017

DATE REVISION

PROJECT NAME:

167-175 WEST 81 STREET NEW YORK, NY 10024

FLASHING AT
PIPE PENETRATION
DETAIL

ORIG. 167-175W81ST/DWGS


15 of 32

PROJECT NO.: 43902-17

DRAWING NO.:

A-306.00

- 1. DETAIL IS SUBJECT TO MODIFICATION DUE TO EXISTING SITE CONDITIONS.
- 2. DETAIL TO BE USED IN CONJUNCTION WITH SOPREMA GENERAL REQUIREMENTS, APPLICATION METHODS AND APPROVED DETAILS.
- 3. ARCHITECT TO INSPECT WATERPROOFING PRIOR TO INSTALLATION OF METAL COPINGS.
- 4. NEW EXHAUST FAN TO MATCH EXISTING SIZE. CONTRACTOR TO VIF.

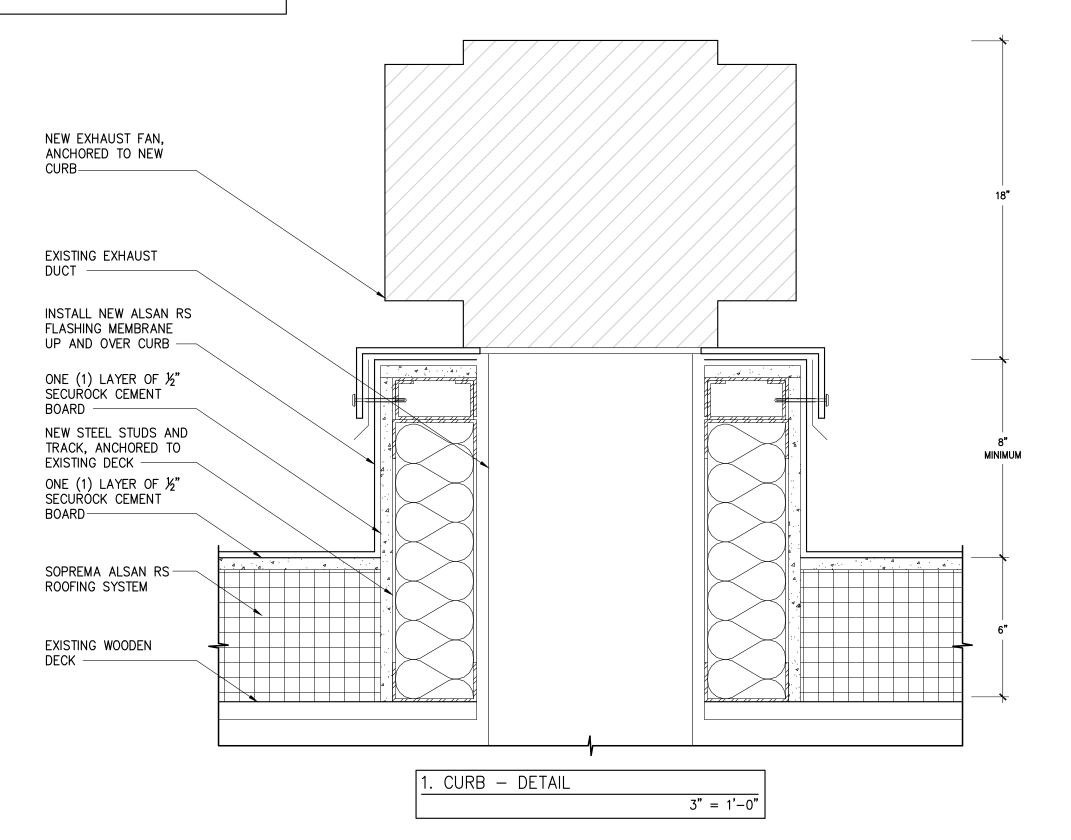

SURFACEDESIGN

40 WORTH STREET SUITE 814 NEW YORK, NY 10013 TEL: 212.757.5659

DRAWINGS IS	SUED:	NOVEMBER	2017
DATE	REVISIO	N	

PROJECT NAME:

167-175 WEST 81 STREET NEW YORK, NY 10024

> ROOF CURB DETAIL


ORIG.


SHEET:

PROJECT NO.: 43902-17


DRAWING NO.:

A-307.00

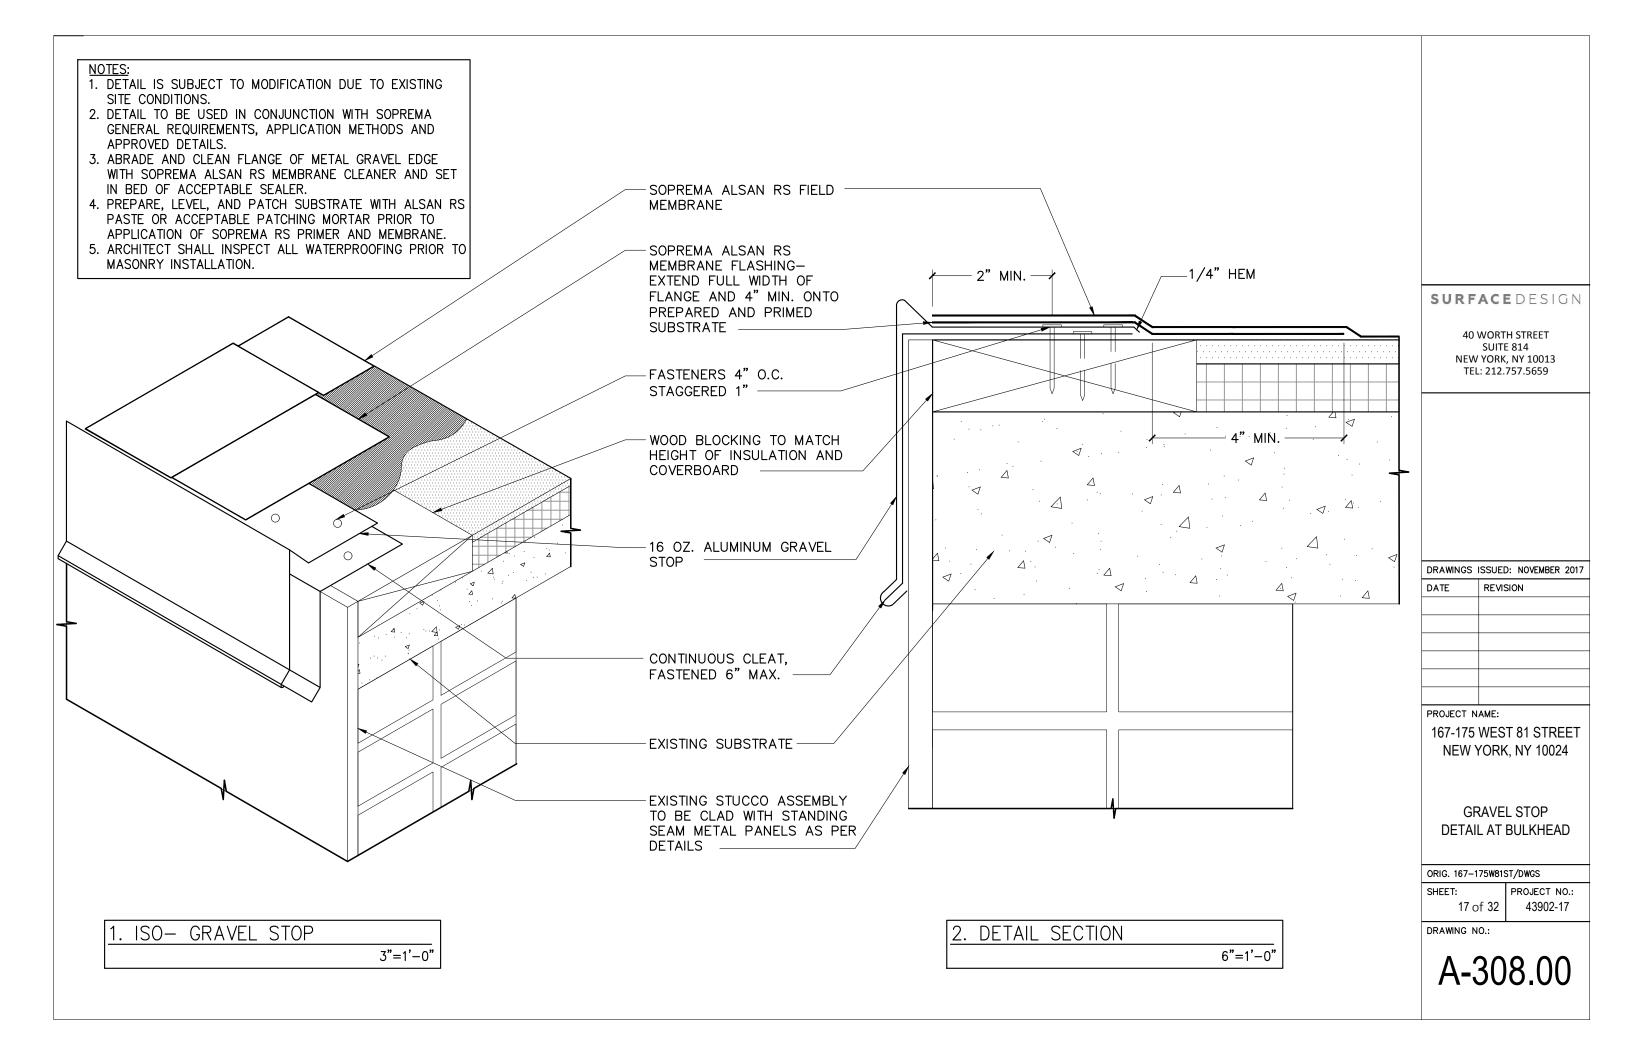


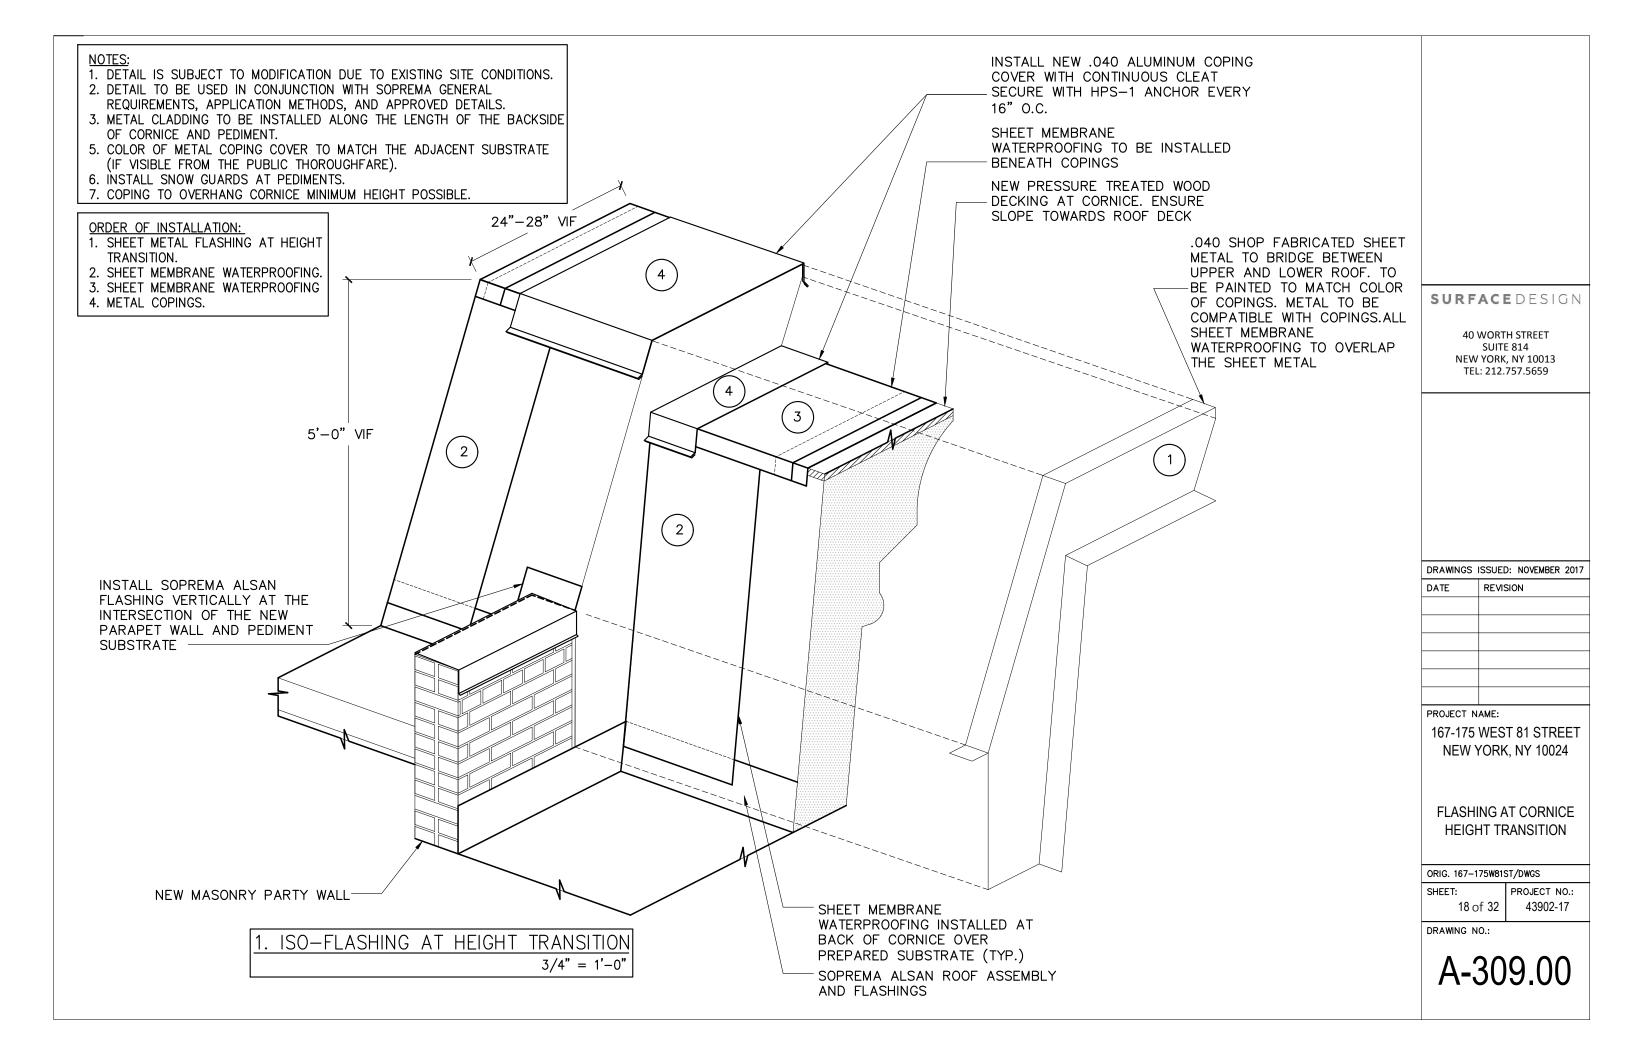

- 1. DETAIL IS SUBJECT TO MODIFICATION DUE TO EXISTING SITE CONDITIONS.
- 2. DETAIL TO BE USED IN CONJUNCTION WITH SOPREMA GENERAL REQUIREMENTS, APPLICATION METHODS, AND APPROVED DETAILS.
- 3. METAL CLADDING TO BE INSTALLED ALONG THE LENGTH OF THE BACKSIDE OF CORNICE AND PEDIMENT.
- 5. COLOR OF METAL COPING COVER TO MATCH THE ADJACENT SUBSTRATE (IF VISIBLE FROM THE PUBLIC THOROUGHFARE).
- 6. INSTALL SNOW GUARDS AT PEDIMENT.

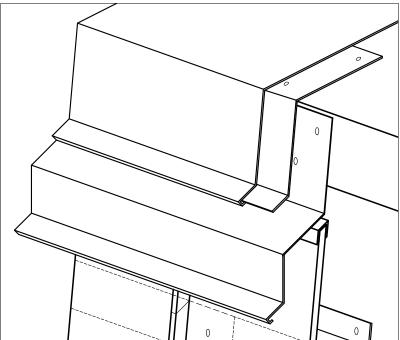

3"=1'-0"

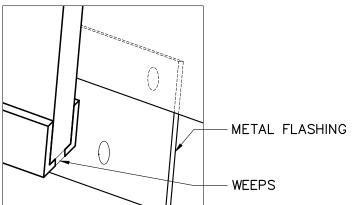

2. BASE OF STANDING SEAM PANEL

3. ISO-STANDING SEAM PANELS 1" = 1'-0"

METAL COPING COVER AND CONTINUOUS CLEAT AS PER DETAIL 24"-28" VIF

NEW PRESSURE TREATED WOOD DECKING AT CORNICE- ENSURE SLOPE TOWARDS ROOF DECK

SHEET MEMBRANE WATERPROOFING OVER PRESSURE TREATED PLYWOOD- TO OVERLAP ONTO MEMBRANE AT SLOPE

METAL FLASHING

STANDING SEAM SHEET METAL CLADDING WITH HIDDEN FASTENER SYSTEM

SUBGIRTS

SHEET MEMBRANE WATERPROOFING OVER SUBSTRATE

SOPREMA ROOFING ASSEMBLY AND FLASHINGS (SEE DETAIL) SURFACEDESIGN

40 WORTH STREET **SUITE 814** NEW YORK, NY 10013 TEL: 212.757.5659

DRAWINGS ISSUED: NOVEMBER 2017

REVISION

PROJECT NAME:

167-175 WEST 81 STREET NEW YORK, NY 10024

> STANDING SEAM METAL CLADDING DETAILS

ORIG. 167-175W81ST/DWGS

SHEET: 19 of 32


PROJECT NO .: 43902-17

DRAWING NO.:

A-310.00



1.CLOSE UP VIEW OF METAL FLASHING

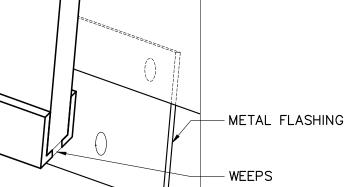


NTS

5'-0" VIF

- 1. DETAIL IS SUBJECT TO MODIFICATION DUE TO EXISTING SITE CONDITIONS.
- 2. DETAIL TO BE USED IN CONJUNCTION WITH SOPREMA GENERAL REQUIREMENTS, APPLICATION METHODS AND APPROVED DETAILS.
- 3. SIZE MASONRY OPENING OF SCUPPER TO MATCH EXISTING BRICK.
- 4. IF LEADER NEEDS TO BE RE-ATTACHED TO THE FACADE, CONTRACTOR TO UTILIZE HPS-1 IMPACT ANCHORS BY HILTI, TO BE INSTALLED WITHIN THE EXISTING MASONRY JOINTS.

 $1 \frac{1}{2}$ " = 1'-0"

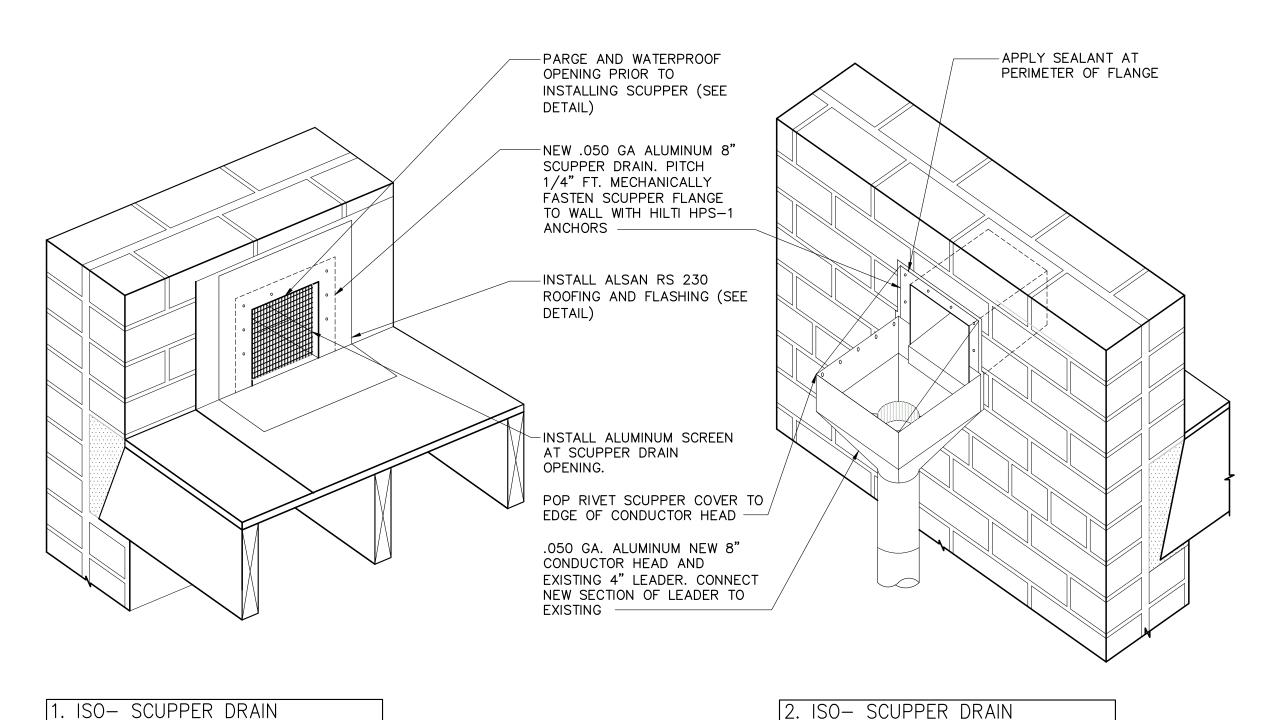

SURFACEDESIGN

40 WORTH STREET SUITE 814 NEW YORK, NY 10013 TEL: 212.757.5659

DRAWINGS ISSUED: NOVEMBER 2017

DATE	REVISION

PROJECT NAME:

167-175 WEST 81 STREET NEW YORK, NY 10024

> SCUPPER DRAIN DETAIL A

ORIG.

 $1 \frac{1}{2}$ " = 1'-0"

SHEET: 20 of 32

PROJECT NO.: 43902-17

DRAWING NO.:


A-311.00

1. DETAIL IS SUBJECT TO MODIFICATION DUE TO EXISTING SITE CONDITIONS. 2. DETAIL TO BE USED IN CONJUNCTION WITH SOPREMA GENERAL

REQUIREMENTS. APPLICATION METHODS. AND APPROVED DETAILS.

STEPS:

- 1. CONTINUE ALSAN RS FLASHING INTO SCUPPER OPENING ON ALL SIDES DURING INSTALLATION OF BASE FLASHING.
- 2. INSTALL NEW THROUGH-WALL SCUPPER, MECHANICALLY FASTENED TO
- 3. INSTALL ALSAN RS WATERPROOFING AS SHOWN TO OVERLAP ONTO METAL SCUPPER.

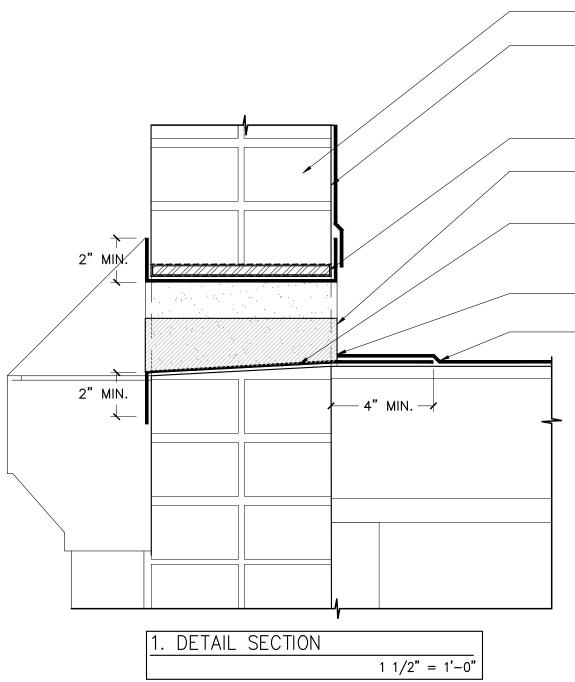

NEW MASONRY PARAPET (SEE DETAIL)

PREPARE, LEVEL AND PATCH SUBSTRATE WITH ALSAN RS PASTE OR ACCEPTABLE PATCHING MORTAR PRIOR TO APPLICATION OF SOPREMA ALSAN RS PRIMER AND MEMBRANE (TYP.)


STEEL PLATE WRAPPED IN WATERPROOFING MEMBRANE.

SOPREMA ALSAN RS MEMBRANE 2" MIN. OVERLAP TO PROVIDE CONTINUOUS FLASHING

ONE PLY SOPREMA ALSAN RS MEMBRANE FLASHING EXTEND THRU TO OUTSIDE OF OPENING AND OVERLAP 2" TO FORM SCUPPER FLASHING

ASSURE FULL SATURATION OF FLEECE AND CONTACT WITH SUBSTRATE

SOPREMA ALSAN RS FIELD MEMBRANE. PROVIDE ADDITIONAL RESIN TO PROMOTE DRAINAGE

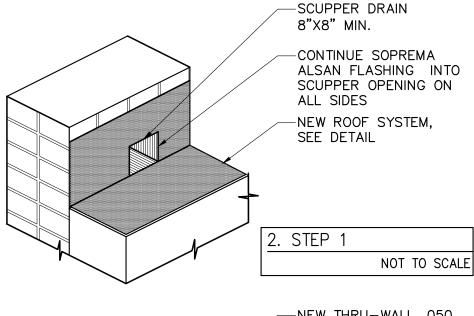

NEW THRU-WALL .050 ALUMINUM OVERFLOW SCUPPER; PITCH 1/4"

MECHANICALLY FASTEN SCUPPER FLANGE TO WALL WITH HILTI HPS-1 **ANCHORS**

APPLY EPOXY PRIMER TO SCUPPER FLANGE AND OPENING

3. STEP 2 NOT TO SCALE

DETAIL B

SURFACEDESIGN

40 WORTH STREET

SUITE 814 NEW YORK, NY 10013

TEL: 212.757.5659

DRAWINGS ISSUED: NOVEMBER 2017

REVISION

167-175 WEST 81 STREET

NEW YORK, NY 10024

SCUPPER DRAIN


ORIG. SHEET:

DATE

PROJECT NO .: 43902-17


DRAWING NO.:


A-312.00

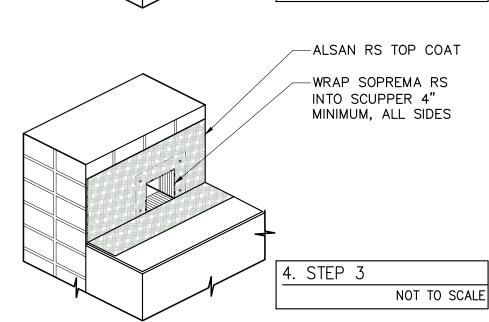


PROJECT NAME:

21 of 32

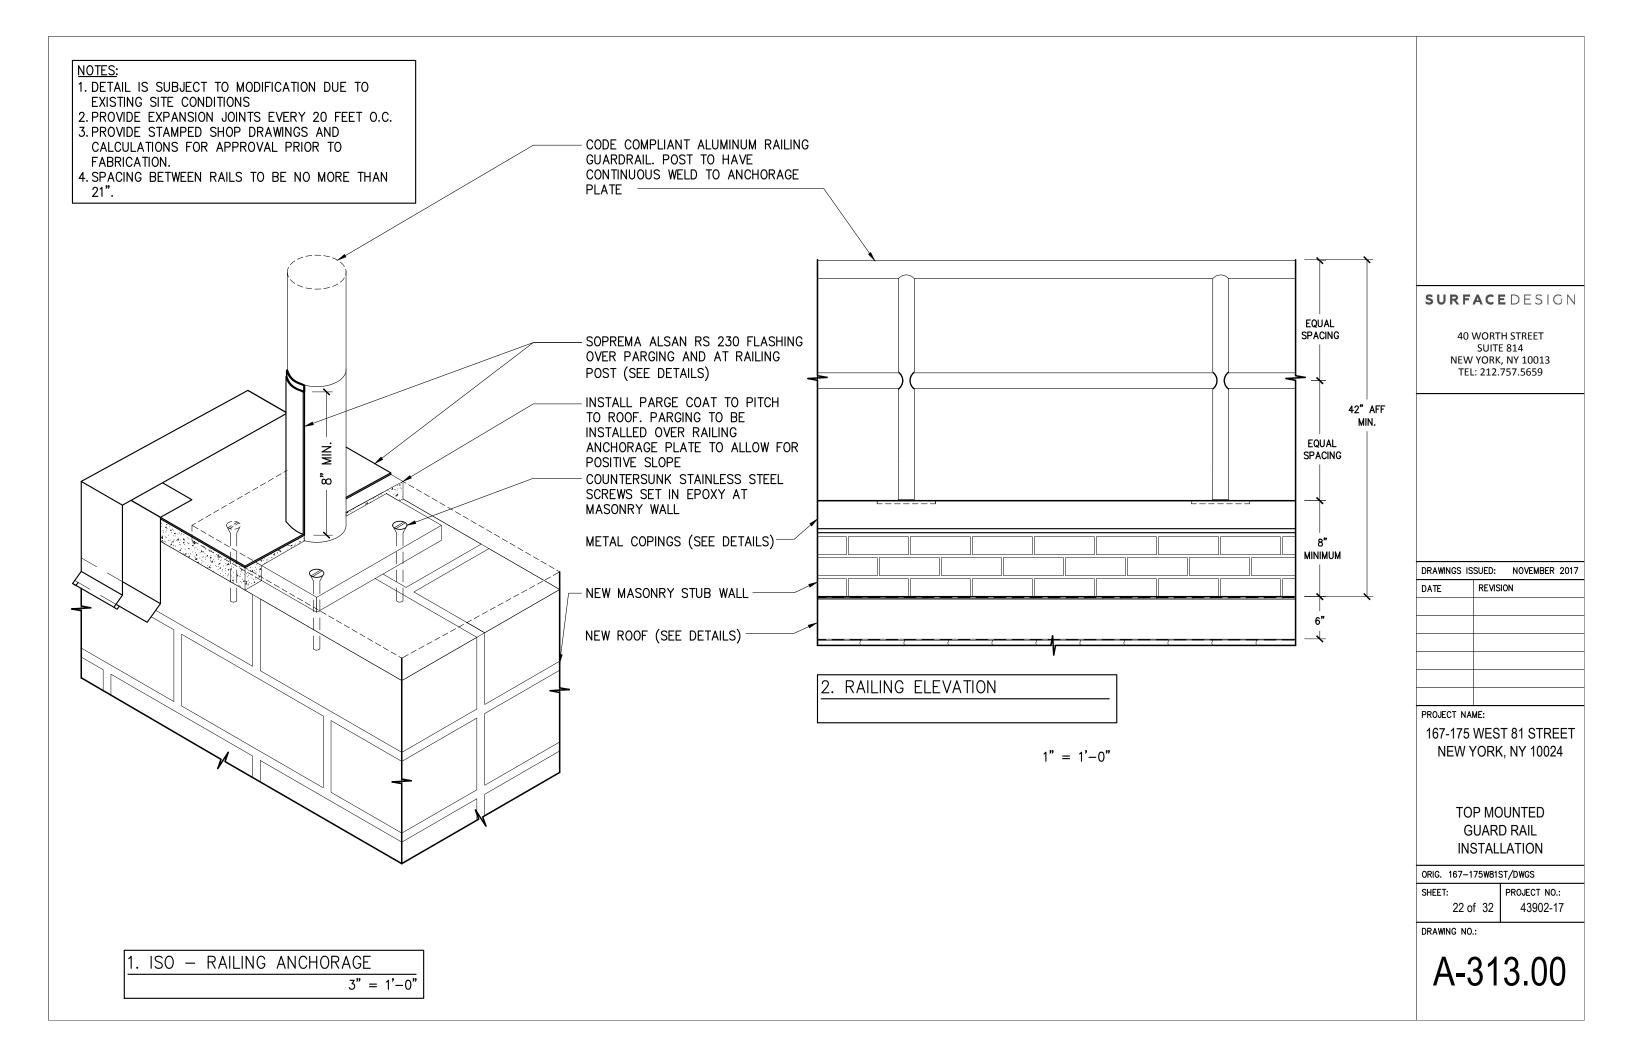

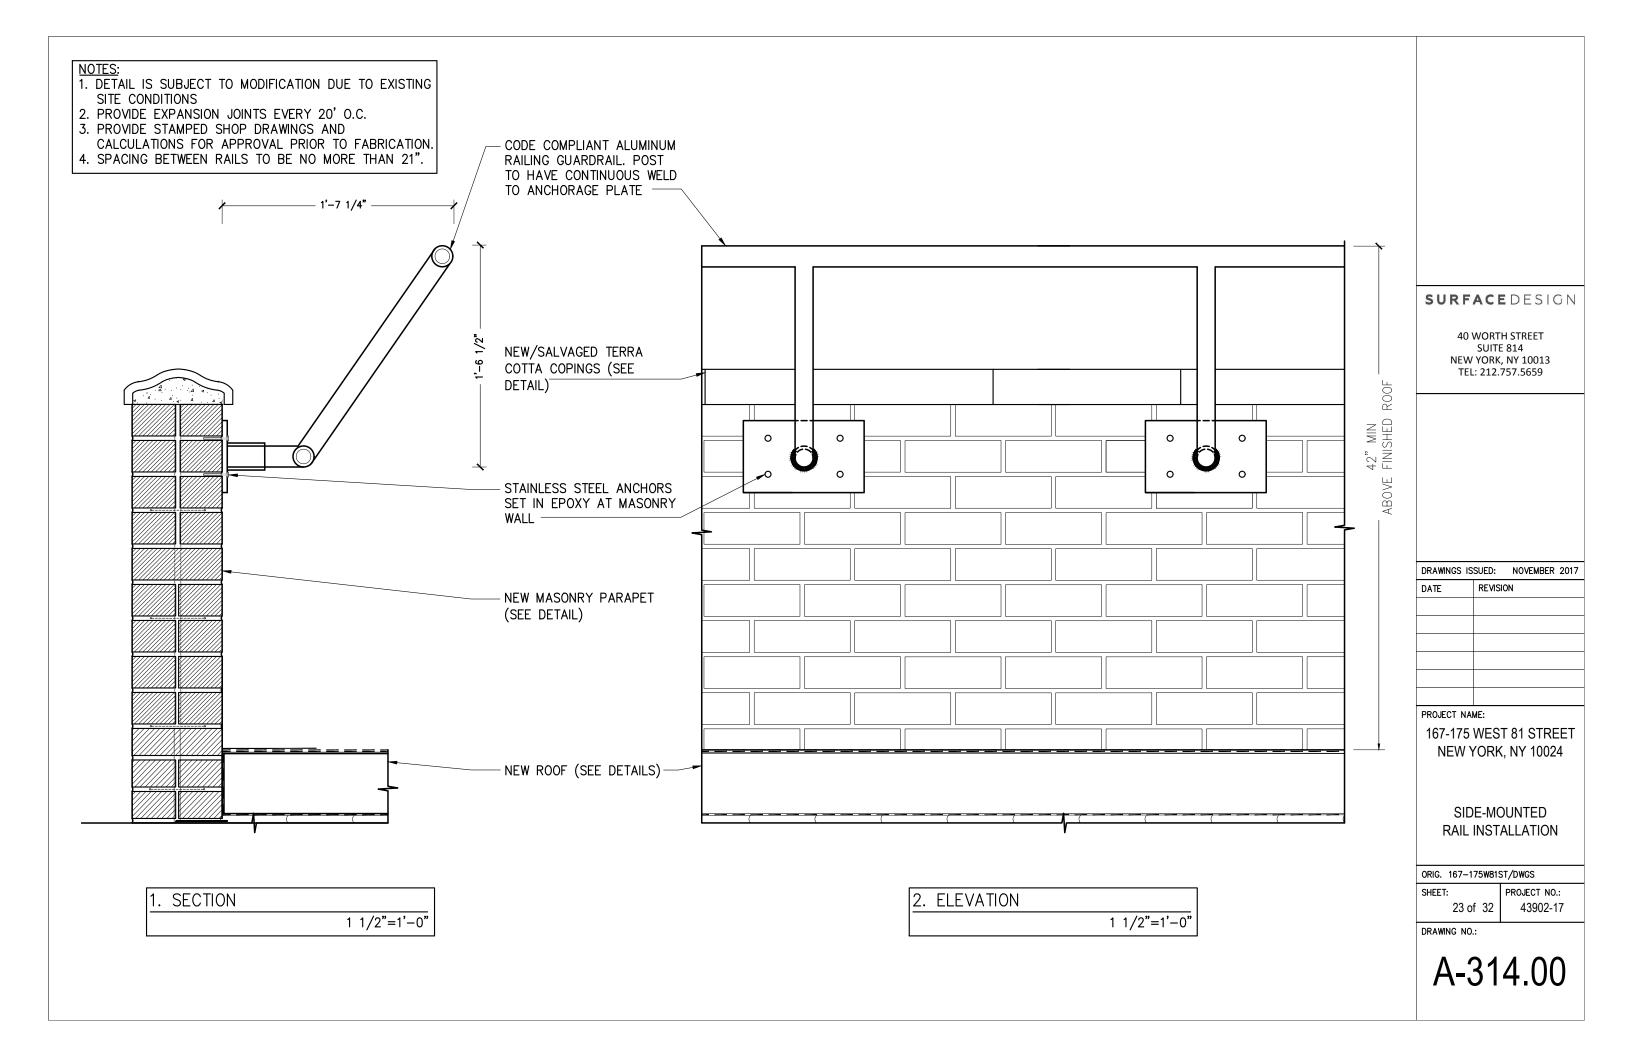

- 1. DETAIL IS SUBJECT TO MODIFICATION DUE TO EXISTING SITE CONDITIONS.
- 2. DETAIL TO BE USED IN CONJUNCTION WITH SOPREMA GENERAL REQUIREMENTS, APPLICATION METHODS, AND APPROVED DETAILS.

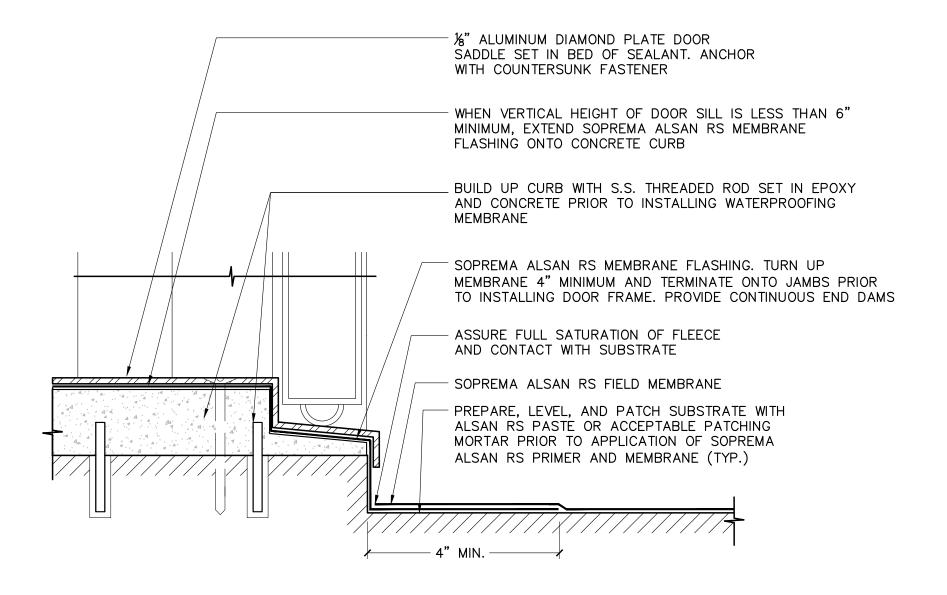

1.	DETAIL	SECTION		
			6" =	<u>1'−0"</u>

SURFACEDESIGN

40 WORTH STREET SUITE 814 NEW YORK, NY 10013 TEL: 212.757.5659

DRAWINGS	SSUED: NOVEMBER 2017
DATE	REVISION

PROJECT NAME:

167-175 WEST 81 STREET NEW YORK, NY 10024

> DOOR SADDLE DETAIL


ORIG. 167-175W81ST/DWGS


SHEET: 24 of 32

PROJECT NO.: 43902-17

DRAWING NO.:

A-315.00

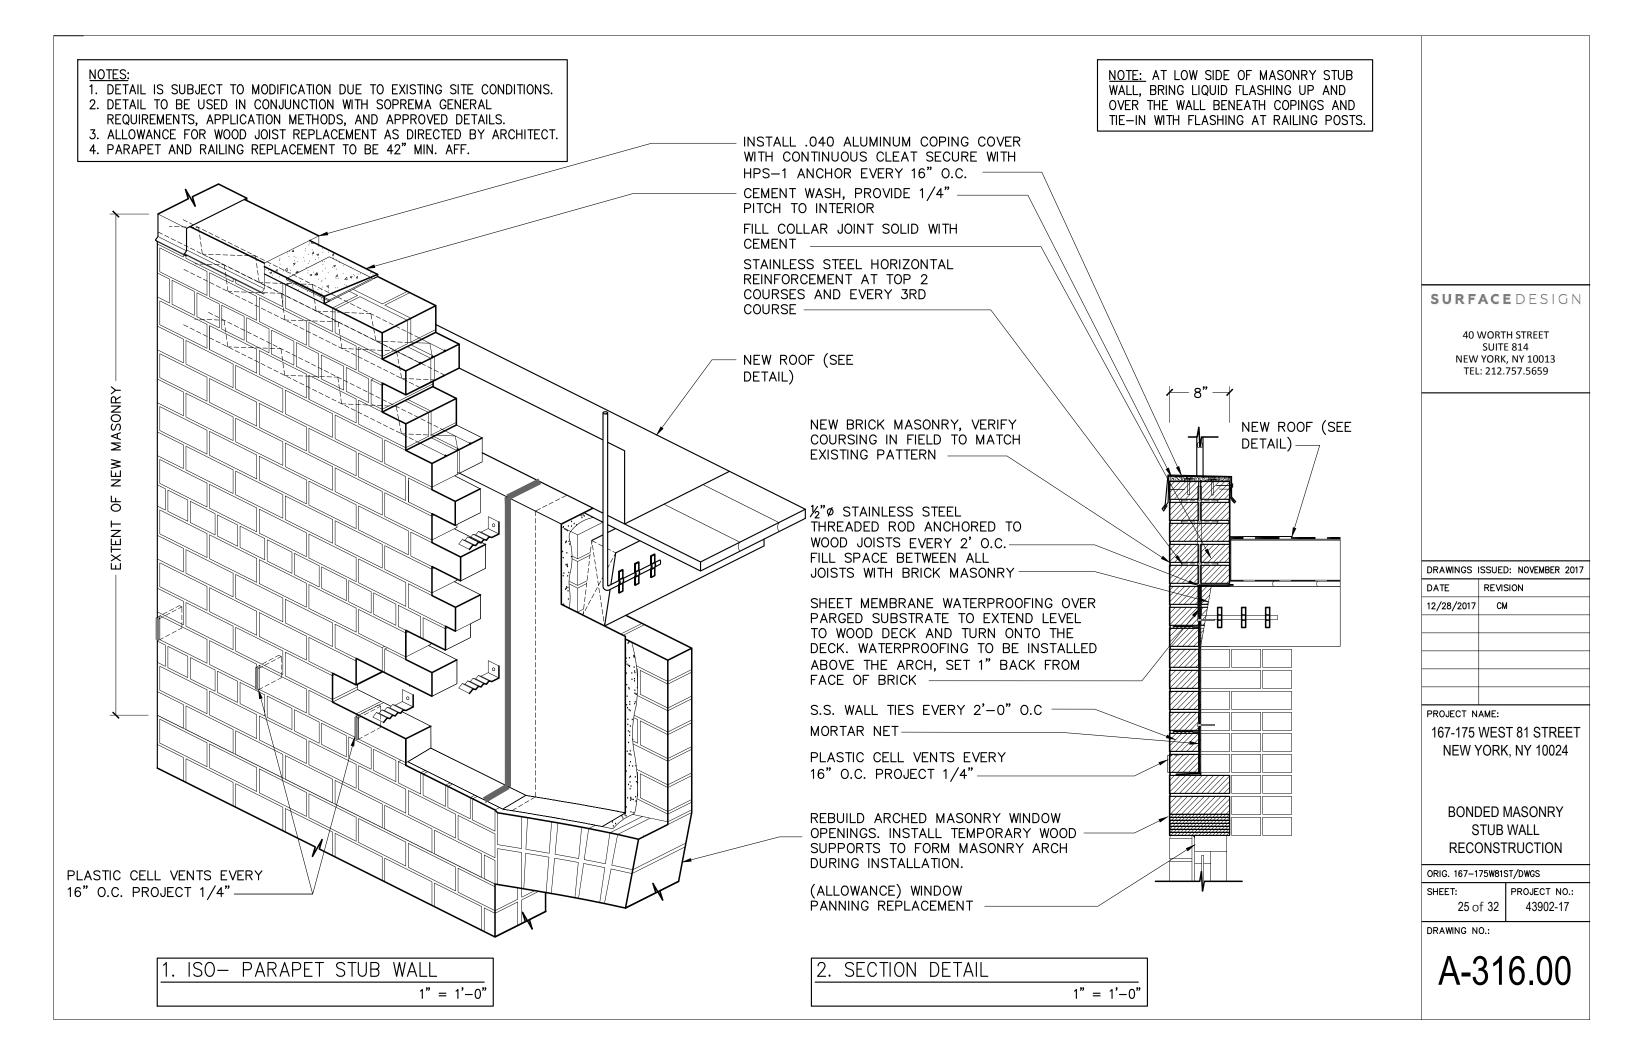

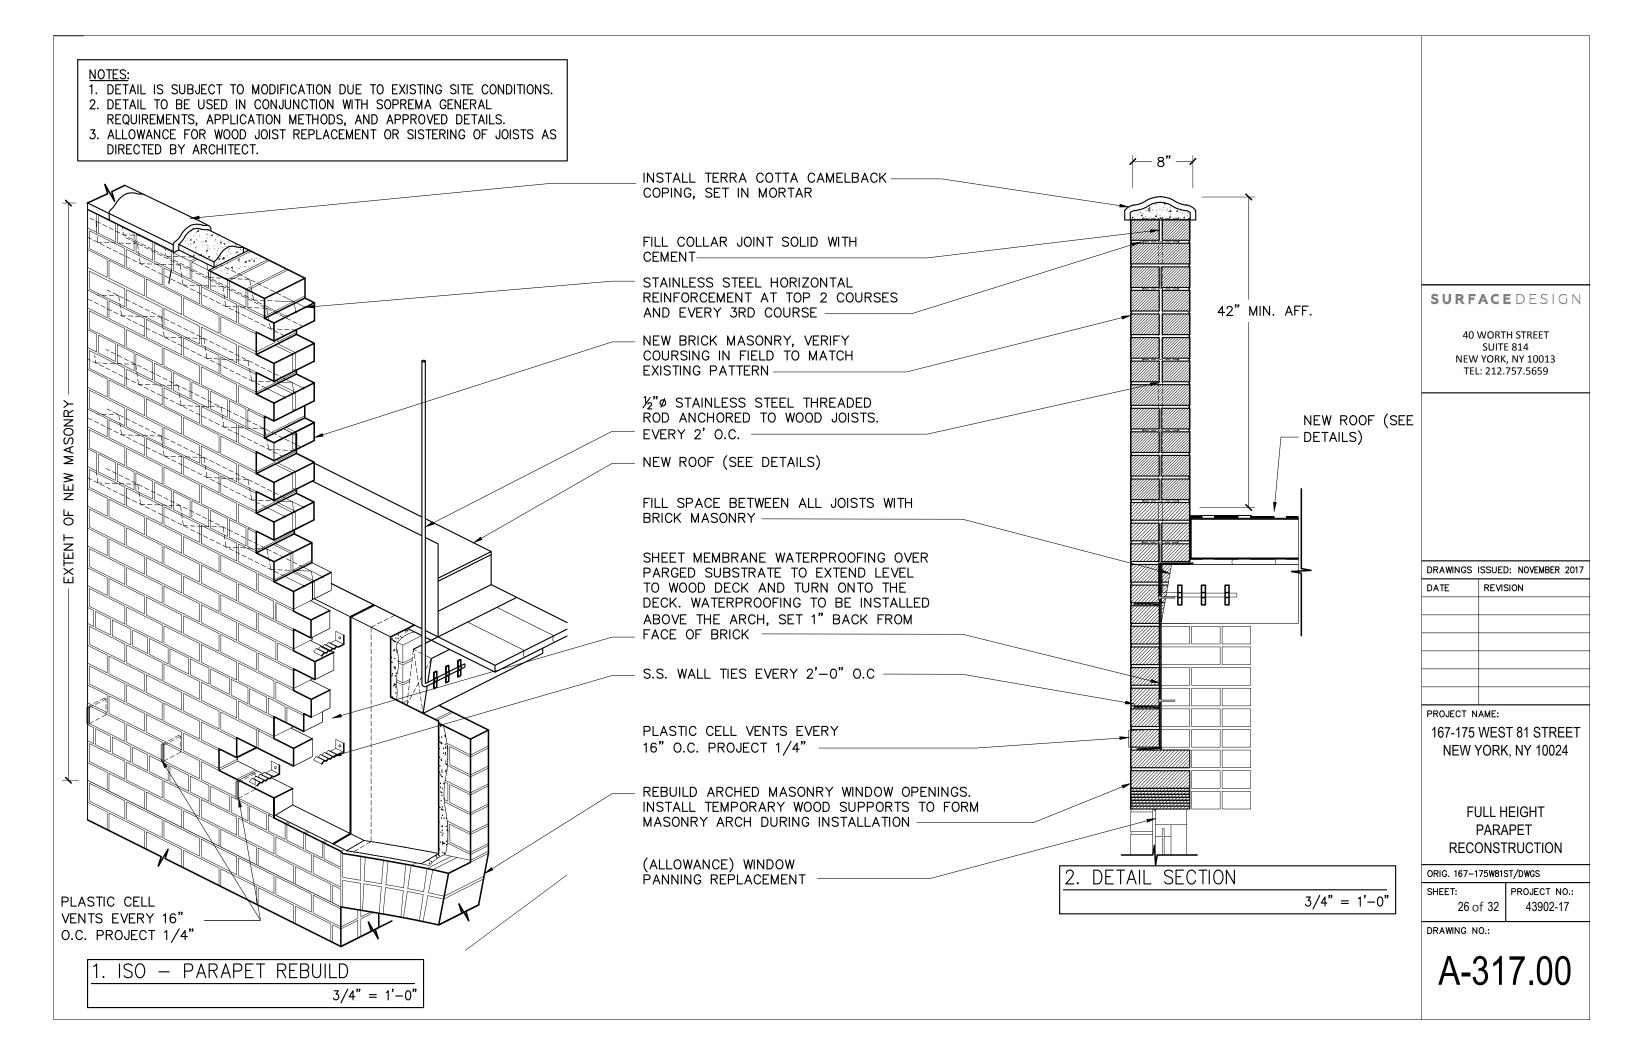


- 1. DETAIL IS SUBJECT TO MODIFICATION DUE TO EXISTING SITE CONDITIONS.
 2. DETAIL TO BE USED IN CONJUNCTION WITH SOPREMA GENERAL
- REQUIREMENTS, APPLICATION METHODS, AND APPROVED DETAILS.
- 3. ALLOWANCE FOR WOOD JOIST REPLACEMENT OR SISTERING OF JOISTS AS DIRECTED BY ARCHITECT.
- 4. PARAPET TO INCREASE ONLY FOUR (4) COURSES IN HEIGHT FROM EXISTING HEIGHT.

1. PARAPET- BEFORE RECONSTRUCTION

3/4" = 1'-0"

5. ALLOW ARCHITECT TO INSPECT ALL WATERPROOFING PRIOR TO MASONRY INSTALLATION.

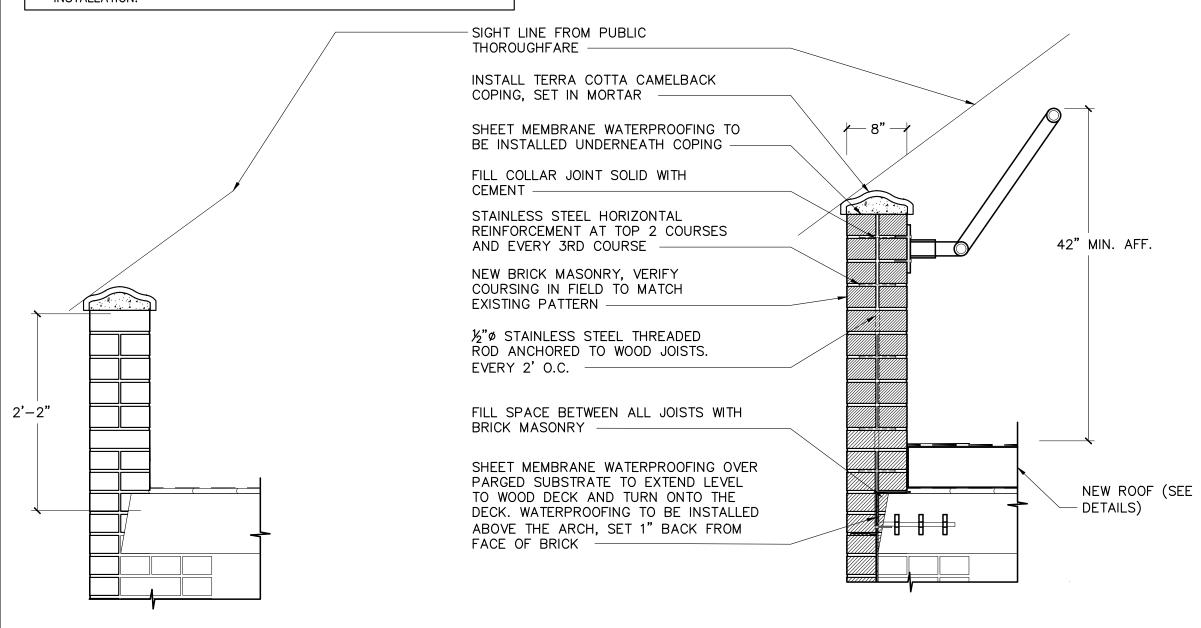

2. PARAPET AFTER RECONSTRUCTION

3/4" = 1'-0"

SURFACEDESIGN

40 WORTH STREET SUITE 814 NEW YORK, NY 10013 TEL: 212.757.5659

DRAWINGS ISSUED: NOVEMBER 2017

DATE REVISION

DATE REVISION

PROJECT NAME:

167-175 WEST 81 STREET NEW YORK, NY 10024

> PARAPET RECONSTRUCTION WITH RAILING


ORIG. 167-175W81ST/DWGS


SHEET: 27 of 32

PROJECT NO.: 43902-17


DRAWING NO.:

A-318.00

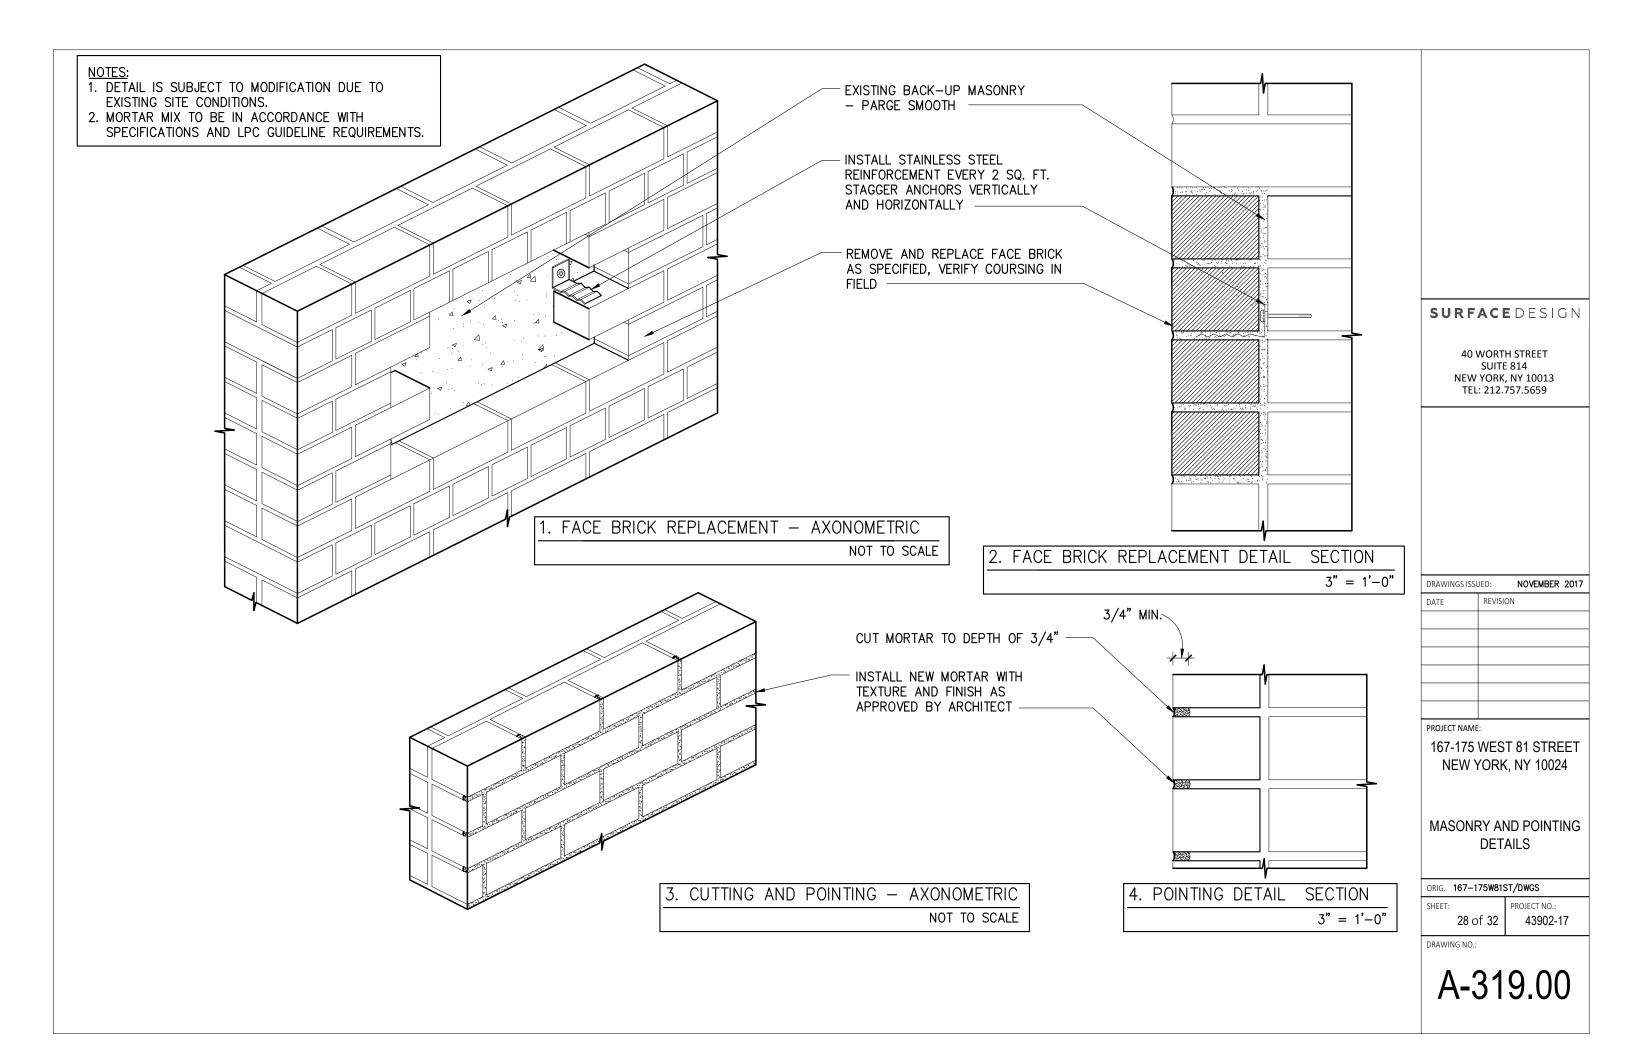

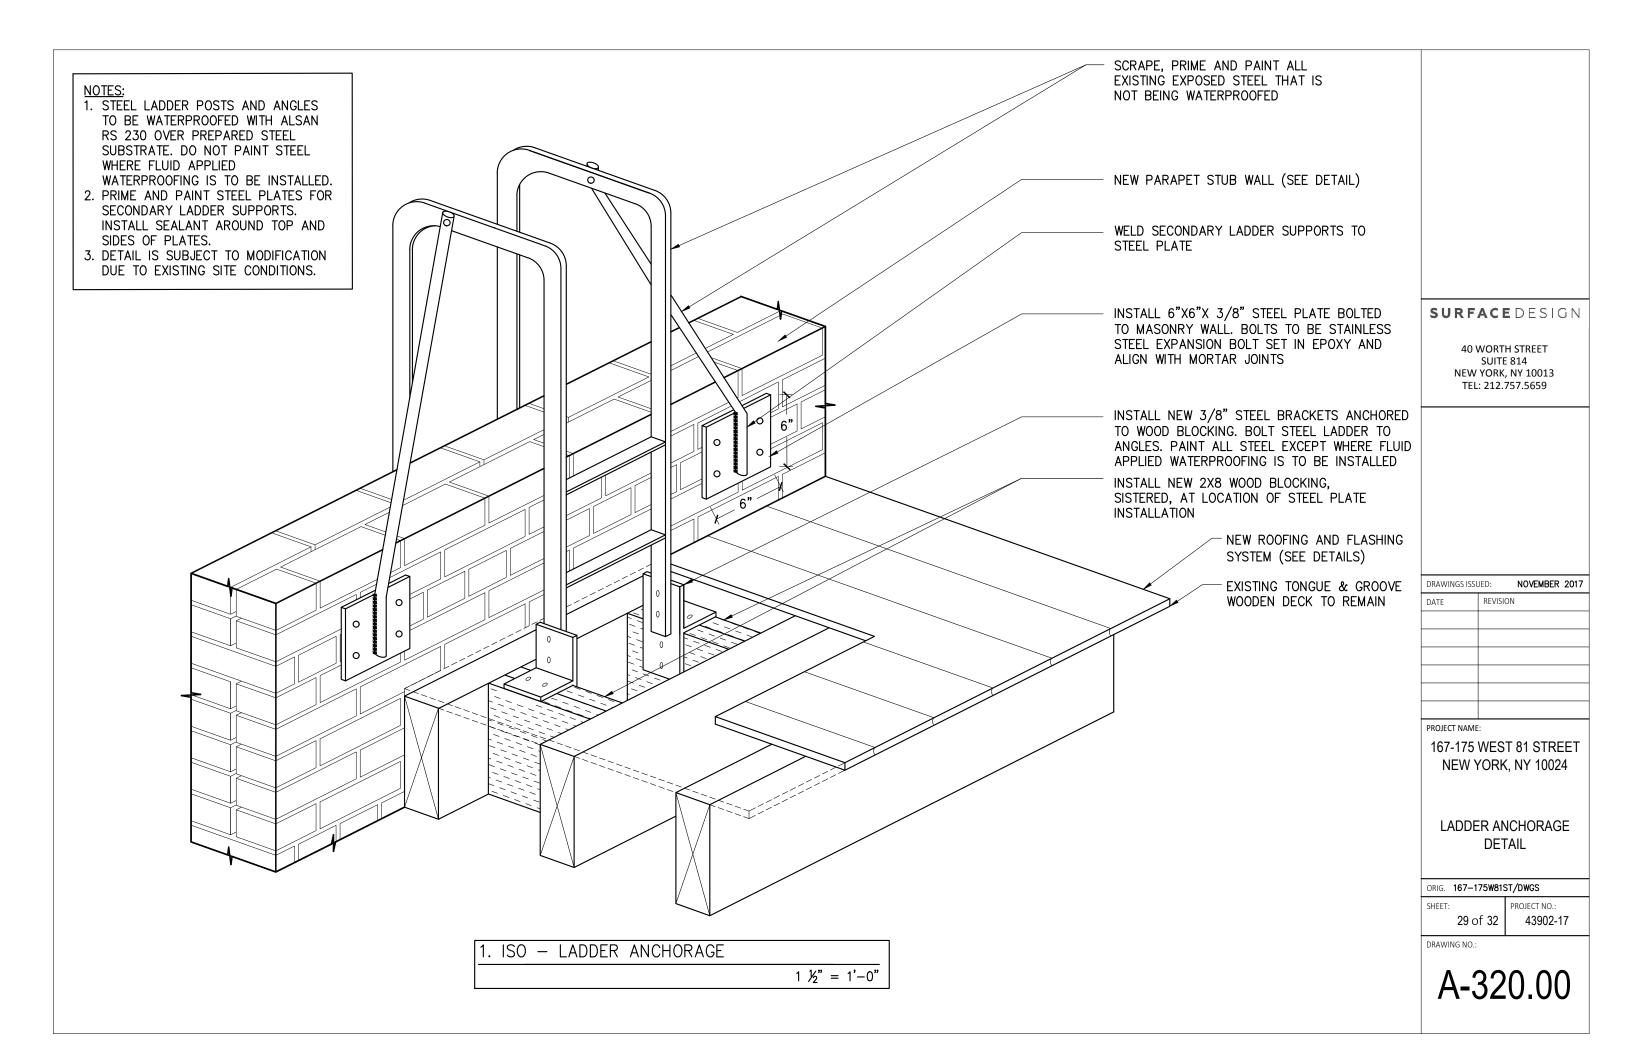

- 1. DETAIL IS SUBJECT TO MODIFICATION DUE TO EXISTING SITE CONDITIONS.
 2. DETAIL TO BE USED IN CONJUNCTION WITH SOPREMA GENERAL
- REQUIREMENTS, APPLICATION METHODS AND APPROVED DETAILS.
- 3. REFER TO RAILING POST DETAIL.
- 4. SOPREMA ALSAN RS LIQUID FLASHINGS TO EXTEND UP AND BENEATH COPING.
- 5. COLOR OF METAL COPING COVER TO BE APPROVED BY OWNER AND TO MATCH THE ADJACENT SUBSTRATE (IF VISIBLE FROM THE PUBLIC THOROUGHFARE).

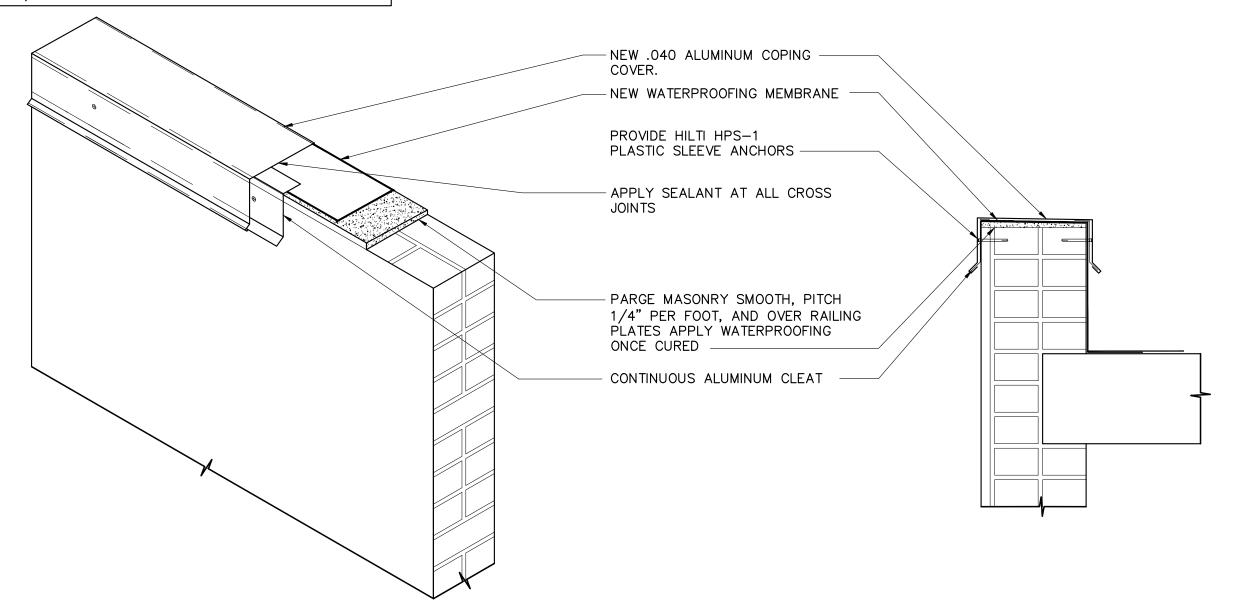

1. AXONOMETRIC - SHEET METAL COPING

1-1/2" = 1'-0"

2. DETAIL SECTION - SHEET METAL COPING

1-1/2" = 1'-0"

SURFACEDESIGN

40 WORTH STREET SUITE 814 NEW YORK, NY 10013 TEL: 212.757.5659

DRAWINGS ISSUED: NOVEMBER 2017

DATE REVISION

PROJECT NAME:

167-175 WEST 81 STREET NEW YORK, NY 10024

SHEET METAL COPING DETAIL

ORIG. 167-175W81ST/DWGS

SHEET: 30 of 32

PROJECT NO.: 43902-17

DRAWING NO.:

A-321.00




- 1. DETAIL IS SUBJECT TO MODIFICATION DUE TO EXISTING SITE CONDITIONS.
- 2. ARCHITECT SHALL INSPECT FRAMING ENDS PRIOR TO PARAPET RECONSTRUCTION / ROOF DECK INSTALLATION.

NEW ¾" EXTERIOR GRADE
PLYWOOD ROOF SHEATHING
TO FILL IN VOID FROM
FORMER CHIMNEY OPENING

NEW 2×4
CONTINUOUS SEATS
FOR ROOF INFILL
SUPPORT

PROVIDE ADDITIONAL
CROSS BRACING AS
DIRECTED BY
ARCHITECT

1. WOOD DECK REPAIR AT OPENING 1 ½" = 1'-0"

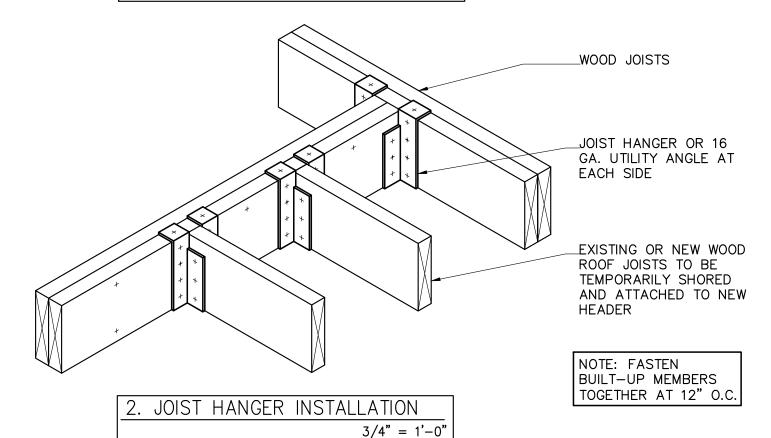

SURFACEDESIGN

40 WORTH STREET SUITE 814 NEW YORK, NY 10013 TEL: 212.757.5659

		DRAWINGS	ISSUED:	NOVEMBER	201
--	--	----------	---------	----------	-----

DATE	REVISION

PROJECT NAME:

167-175 WEST 81 STREET NEW YORK, NY 10024

> WOOD FRAMING DETAILS A

ORIG. 167-175W81ST/DWGS


31 of 32

PROJECT NO.: 43902-17

DRAWING NO.:

A-322.00

- 1. DETAIL IS SUBJECT TO MODIFICATION DUE TO EXISTING SITE CONDITIONS.
- 2. ARCHITECT SHALL INSPECT FRAMING ENDS PRIOR TO PARAPET RECONSTRUCTION / ROOF DECK INSTALLATION.

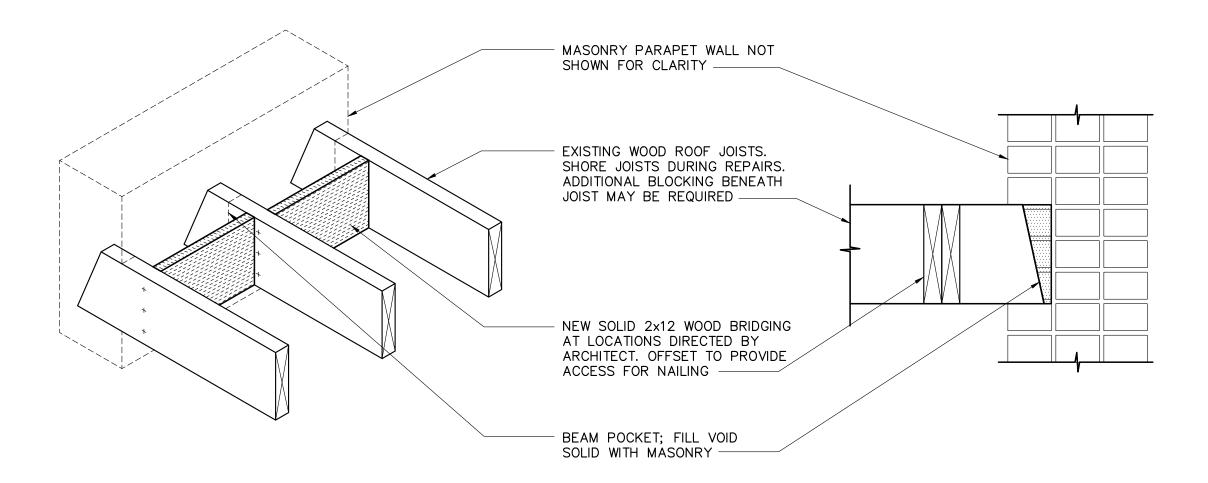

1. AXONOMETRIC - JOIST BRIDGING

3/4" = 1'-0"

2. DETAIL SECTION - JOIST BRIDGING

1-1/2" = 1'-0"

SURFACEDESIGN

40 WORTH STREET SUITE 814 NEW YORK, NY 10013 TEL: 212.757.5659

DRAWINGS ISSUED: NOVEMBER 2017

DATE REVISION

PROJECT NAME:

167-175 WEST 81 STREET NEW YORK, NY 10024

> WOOD FRAMING DETAILS B

ORIG. 167-175W81ST/DWGS

SHEET: 32 of 32

PROJECT NO.: 43902-17

DRAWING NO.:

A-323.00