

NOTES:

1. CONSTRUCTION FENCE SHALL BE PAINTED HUNTER (OR DARK) GREEN.

2. CONTRACTOR IS RESPONIBLE FOR LOCATING FENCE ON SITE AS

REQUIRED BY THEIR CONSTRUCTION ACTIVITIES, SITE SAFETY

3. PROVIDE 12"x12" VIEWING PANELS ENCLOSED WITH PLEXIGLAS OR A

SIMILAR MATERIAL @ 25' O.C. @FRONTAGE. THE TOP OF THE

LEVEL OF THE GROUND, AND THE BOTTOM OF THE VIEWING PANEL

MUST BE LOCATED NO LESS THAN 3 FEET ABOVE THE LEVEL OF THE

4. CONSTRUCTION FENCES MUST HAVE PROJECT INFORMATION PANELS

VIEWING PANEL MUST BE LOCATED NO MORE THAN 6 FEET ABOVE THE

THAT MEET STYLE, GUIDE CONTENT, COLOR, FONT, MATERIAL, AND SIZE

CONSTRUCTION FENCE DETAIL

PROGRAM AND NYC REQUIREMENTS.

REQUIREMENTS AS PER NYC DOB.

SCALE: 3/8"=1'-0"

4'-0" 4'-0" 2"x4" P.T. WOOD GIRT, 3'-6" O.C. · 4'-0"X8'-0"X 🖯" THK EXTERIOR GRADE PLYWOOD PANEL - 4"x4" P.T. WOOD POST, 8'-0" O.C. -GRADE

FENCE ELEVATION

FENCE SECTION

CPANEL/ POST

CPANEL JOINT

CPANEL/ POST

SPECIAL INSPECTIONS

ALL MATERIALS DESIGNATED FOR "CONTROLLED INSPECTION" SHALL BE INSPECTED AND/OR TESTED TO VERIFY COMPLIANCE WITH CODE REQUIREMENTS, UNLESS OTHERWISE SPECIFICALLY PROVIDED BY CODE PROVISIONS. ALL REQUIRED INSPECTIONS AND TESTS OF MATERIAL SHALL BE MADE AND/OR WITNESSED BY OR UNDER THE DIRECT SUPERVISION OF AN ARCHITECT OR ENGINEER RETAINED BY OR ON BEHALF OF THE OWNER OR LESSEE.

OWNER WILL ENGAGE AND PAY FOR A SPECIAL INSPECTOR AND AN INDEPENDENT TESTING AGENCY TO PERFORM THE FOLLOWING SPECIAL INSPECTION AS SPECIFIED ON THE APPLICABLE SECTIONS OF THE NEW YORK CITY BUILDING CODE, CHAPTER 17, SECTION 1704. TECHNICAL REPORT STATEMENT OF RESPONSIBILITY TR-1 FORM SHALL BE FILLED WITH THE BUILDING DEPARTMENT FOR APPROVAL OF SPECIAL INSPECTOR. IT IS THE CONTRACTOR'S RESPONSIBILITY TO PROVIDE ADEQUATE PRIOR NOTICE FOR COMPLETION OF INSPECTIONS.

SPECIAL INSPECTIONS CONCRETE - CAST-IN PLACE BC 1704.4 SUB-GRADE INSPECTION BC 1704.7.1 SUBSURFACE INVESTIGATIONS (BORINGS/TEST PITS) BC 1704.7.4 STRUCTURAL STABILITY BC 1704.20.1 RAISING AND MOVING OF A BUILDING BC 1704.20.5 HEATING SYSTEMS BC 1704.25 FIRE-RESISTANT PENETRATIONS AND JOINTS BC 1704.27 FLOOD ZONE COMPLIANCE BC1704.29, BC G105

PROGRESS INSPECTIONS FOOTING AND FOUNDATION BC 110.3.1 LOWEST FLOOR ELEVATION BC 110.3.2 STRUCTURAL WOOD FRAME BC 110.3.3 **ENERGY CODE COMPLIANCE INSPECTIONS** BC 110.3.5 FIRE-RESISTANCE RATED CONSTRUCTION BC 110.3.4

ENERGY CODE PROGRESS INSPECTIONS REQUIRED INSULATION PLACEMENT AND R- VALUES IA2 AIR SEALING AND INSULATION - VISUAL SHUTOFF DAMPERS HVAC AND SERVICE WATER HEATING EQUIPMENT HVAC AND SERVICE WATER HEATING CONTROLS ID1 MAINTENANCE INFORMATION PERMANENT CERTIFICATE ID2

FIRE RATING AS PER TABLE 3-4 (CLASS II-D) EXTERIOR WALLS MORE THAN 3'-0" BUT LESS THAN 15'-0" FROM PROPERTY LINE

1HR RATED - 1HR RATED EXTERIOR WALLS PROVIDED COLUMNS SUPPORT ONE FLOOR (SUPPORTING ROOF LEVEL) 1HR RATED - 1HR COLUMN ENCLOSURES PROVIDED FLOOR CONSTRUCTION INCLUDING BEAMS, ETC 1HR RATED - 1 HR RATED FLOOR CONSTRUCTION PROVIDED ROOF CONSTRUCTION INCLUDING BEAMS, ETC **NO RATING - 1 HR**

RATED CEILING PROVIDED, ROOF CONSTRUCTION DOES NOT REQUIRE A RATED

(TABULATED RATINGS FOR ROOF CONSTRUCTION APPLY TO BUILDINGS OVER 1 STORY IN HEIGHT. AS PER NOTE "h" OF TABLE 3-4, IN ONE STORY BUILDINGS ROOF CONSTRUCTION MAY BE OF MATERIAL 0 HOUR FIRE-RESISTANCE RATING)

SEE DETAILS ON SHEET A-003 FOR ASSEMBLY DETAILS SEE PLAN ON SHEET A-002 FOR COLUMN ENCLOSURE LOCATIONS

ASSEMBLY (SEE NOTE)

DRAWING LIST

T-0001 TITLE PAGE

FRONT YARD

REAR YARD

SPRINKLERED

MIN. SIDE YARD

TOTAL SIDE YARD

BUILDING HEIGHT

Z-001.03 ZONING ANALYSIS, SITE / PLOT PLAN, CONSTRUCTION FENCE DETAIL

G-001 F.J.R.M. & ZONING MAPS, AERIAL PHOTO

GENERAL NOTES, TAX BILL & ENERGY ANALYSIS GENERAL NOTES, DETAILS, AND SCHEDULE WOOD FRAMING, DETAILS & NOTES

A-001 (ØMITTED) A-002.03 PROPOSED FIRST FLOOR PLAN A-003.03PROPOSED SECOND FLOOR PLAN A-004 PROPOSED FRONT AND SIDE ELEVATIONS

A-005.02 PROPOSED REAR AND SIDE ELEVATIONS

A-006.02 PROPOSED SECTION AND DETAILS

P-001.03 PLUMBING RISER DIAGRAMS AND DETAILS

PROJECT ZONING DATA					
MAP / BLOCK / LOT			27B /4092/ 21		
ZONING DISTRICT			R	3X	
P.B.F.E.			AE B.F.E 13'-0	' (D.F.E.: 15'-0')	
FIRE DISTRICT			N	0	
OCCUPANCY CLASSIFICATION			1968 BC	- J-3 RES	
CONSTRUCTION CLASSIFICATION			1968 BC -	CLASS II D	
CERTIFICATE OF OCCUPANCY			N	0	
LOT AREA			2,400	SF	
EXISTING FLOOR AREA					
EXI	STING FIRST FL	OOR DWELLING	1,140	SF	
EXISTI	NG SECOND FL	OOR DWELLING	N/A	N/A	
TOTAL EXISTING STRUCTURES			1,140	SF	
PROPOSED FLOOR AREA					
PROP	OSED FIRST FL	OOR DWELLING	1,140	SF	
PROPOSED SECOND FLOOR DWELLING			N/A	N/A	
ALLOWABLE DEDUCTIONS (UTILITY CLOSET)			15	SF	
TOTAL PROPOSED STRUCTURES			1,125	SF	
FAR CALCULATION				•	
ACTUAL FLOOR AREA RATIO			0.475		* HEIGHT REQUIREMENT MAY
ALLOWABLE FLOOR AREA RATIO			0	.5	BE MEASURED FROM FRCE AS PER 64-131
SETBACK REQUIREMENTS	R3X MIN. REQ	EXISTING	PROPOSED	COMPLIES	NON-COMPLIANCE ALLOWED AS PER ZR SEC/

10'-0" MIN.

10'-0" MIN.

(ZR 23-45)

(ZR 23-461)

(ZR 23-631)

(ZR 23-461) 2'-0" MIN.

(ZR 23-47) 30'-0" MIN.

PLANTING	(ZR 23-451)	30% OF LOT	N/A	12'-0"		
	,				I	
FLOOR AREA RAT	10	R3X	EXISTING	PROPOSED	COMPLIES	NON-COMPLIANCE ALLOWED AS PER ZR ART. 4 (COMPLIANCE)
LOT AREA	(ZR-23-32)	3,325 S.F. MIN	2,400 SF	2,400 SF	NO	64-723
LOT WIDTH	(ZR 23-32)	35' MIN.	40'	40'	YES	
FLOOR AREA	(ZR 23-142)	N/A	1,140 SF	1,140 SF	YES	
FLOOR AREA RATI	O (ZR 23-142)	0.5 MAX	.475	.475	YES	
LOT COVERAGE	(ZR 23-142)	R3X MAX	EXISTING	PROPOSED	COMPLIES	
FOOTPRINT AREA	S.F.	Governed by Yard	1,140 SF	1,140 SF	YES	

9'-2 $\frac{1}{2}$ "

9'-6"

6'-3 $\frac{1}{2}$ "

 $24'-2\frac{3}{4}''$

2'-6" and 7'-0" 2'-6" and 7'-0"

9'-2 $\frac{1}{2}$ "

9'-6"

6'-3 $\frac{1}{2}$ "

32'-7 3" * (FROM FRCE)

NO

NO

NO

NO

YES

TOOTI KIINT AKLA O.I.	Governed by faid	1,140 01	1,140 01	ILS		Ο	
LOT COVERAGE %	Requirements	Complies	Complies	YES		A R	
					* Per Section 6.1 of the	В	
PARKING SPACE	R3X MAX	EXISTING	PROPOSED	COMPLIES	ACCELERATE BUILD IT BACK GUIDE, no parking is required if the property did not	Α	
PARKING SPACE (MINIMUM)	1	1	1	YES	previously provide off-street		
					parking		

** SPRINKLER WILL BE FILED UNDER SEPARATE APPLICATION

PAA	REV	DESCRIPTION	DATE
		DWG LIST PAA UPDATE	12-18-17
<u> 1</u>		DWG LIST MIN PLAN CHANGE	3-29-18
<u>^2</u> \		PAA Dwg. No. changes	7-16-18

Z 33 N TATEN

(COMPLIANCE)

64-723

64-723

64-723

64-723

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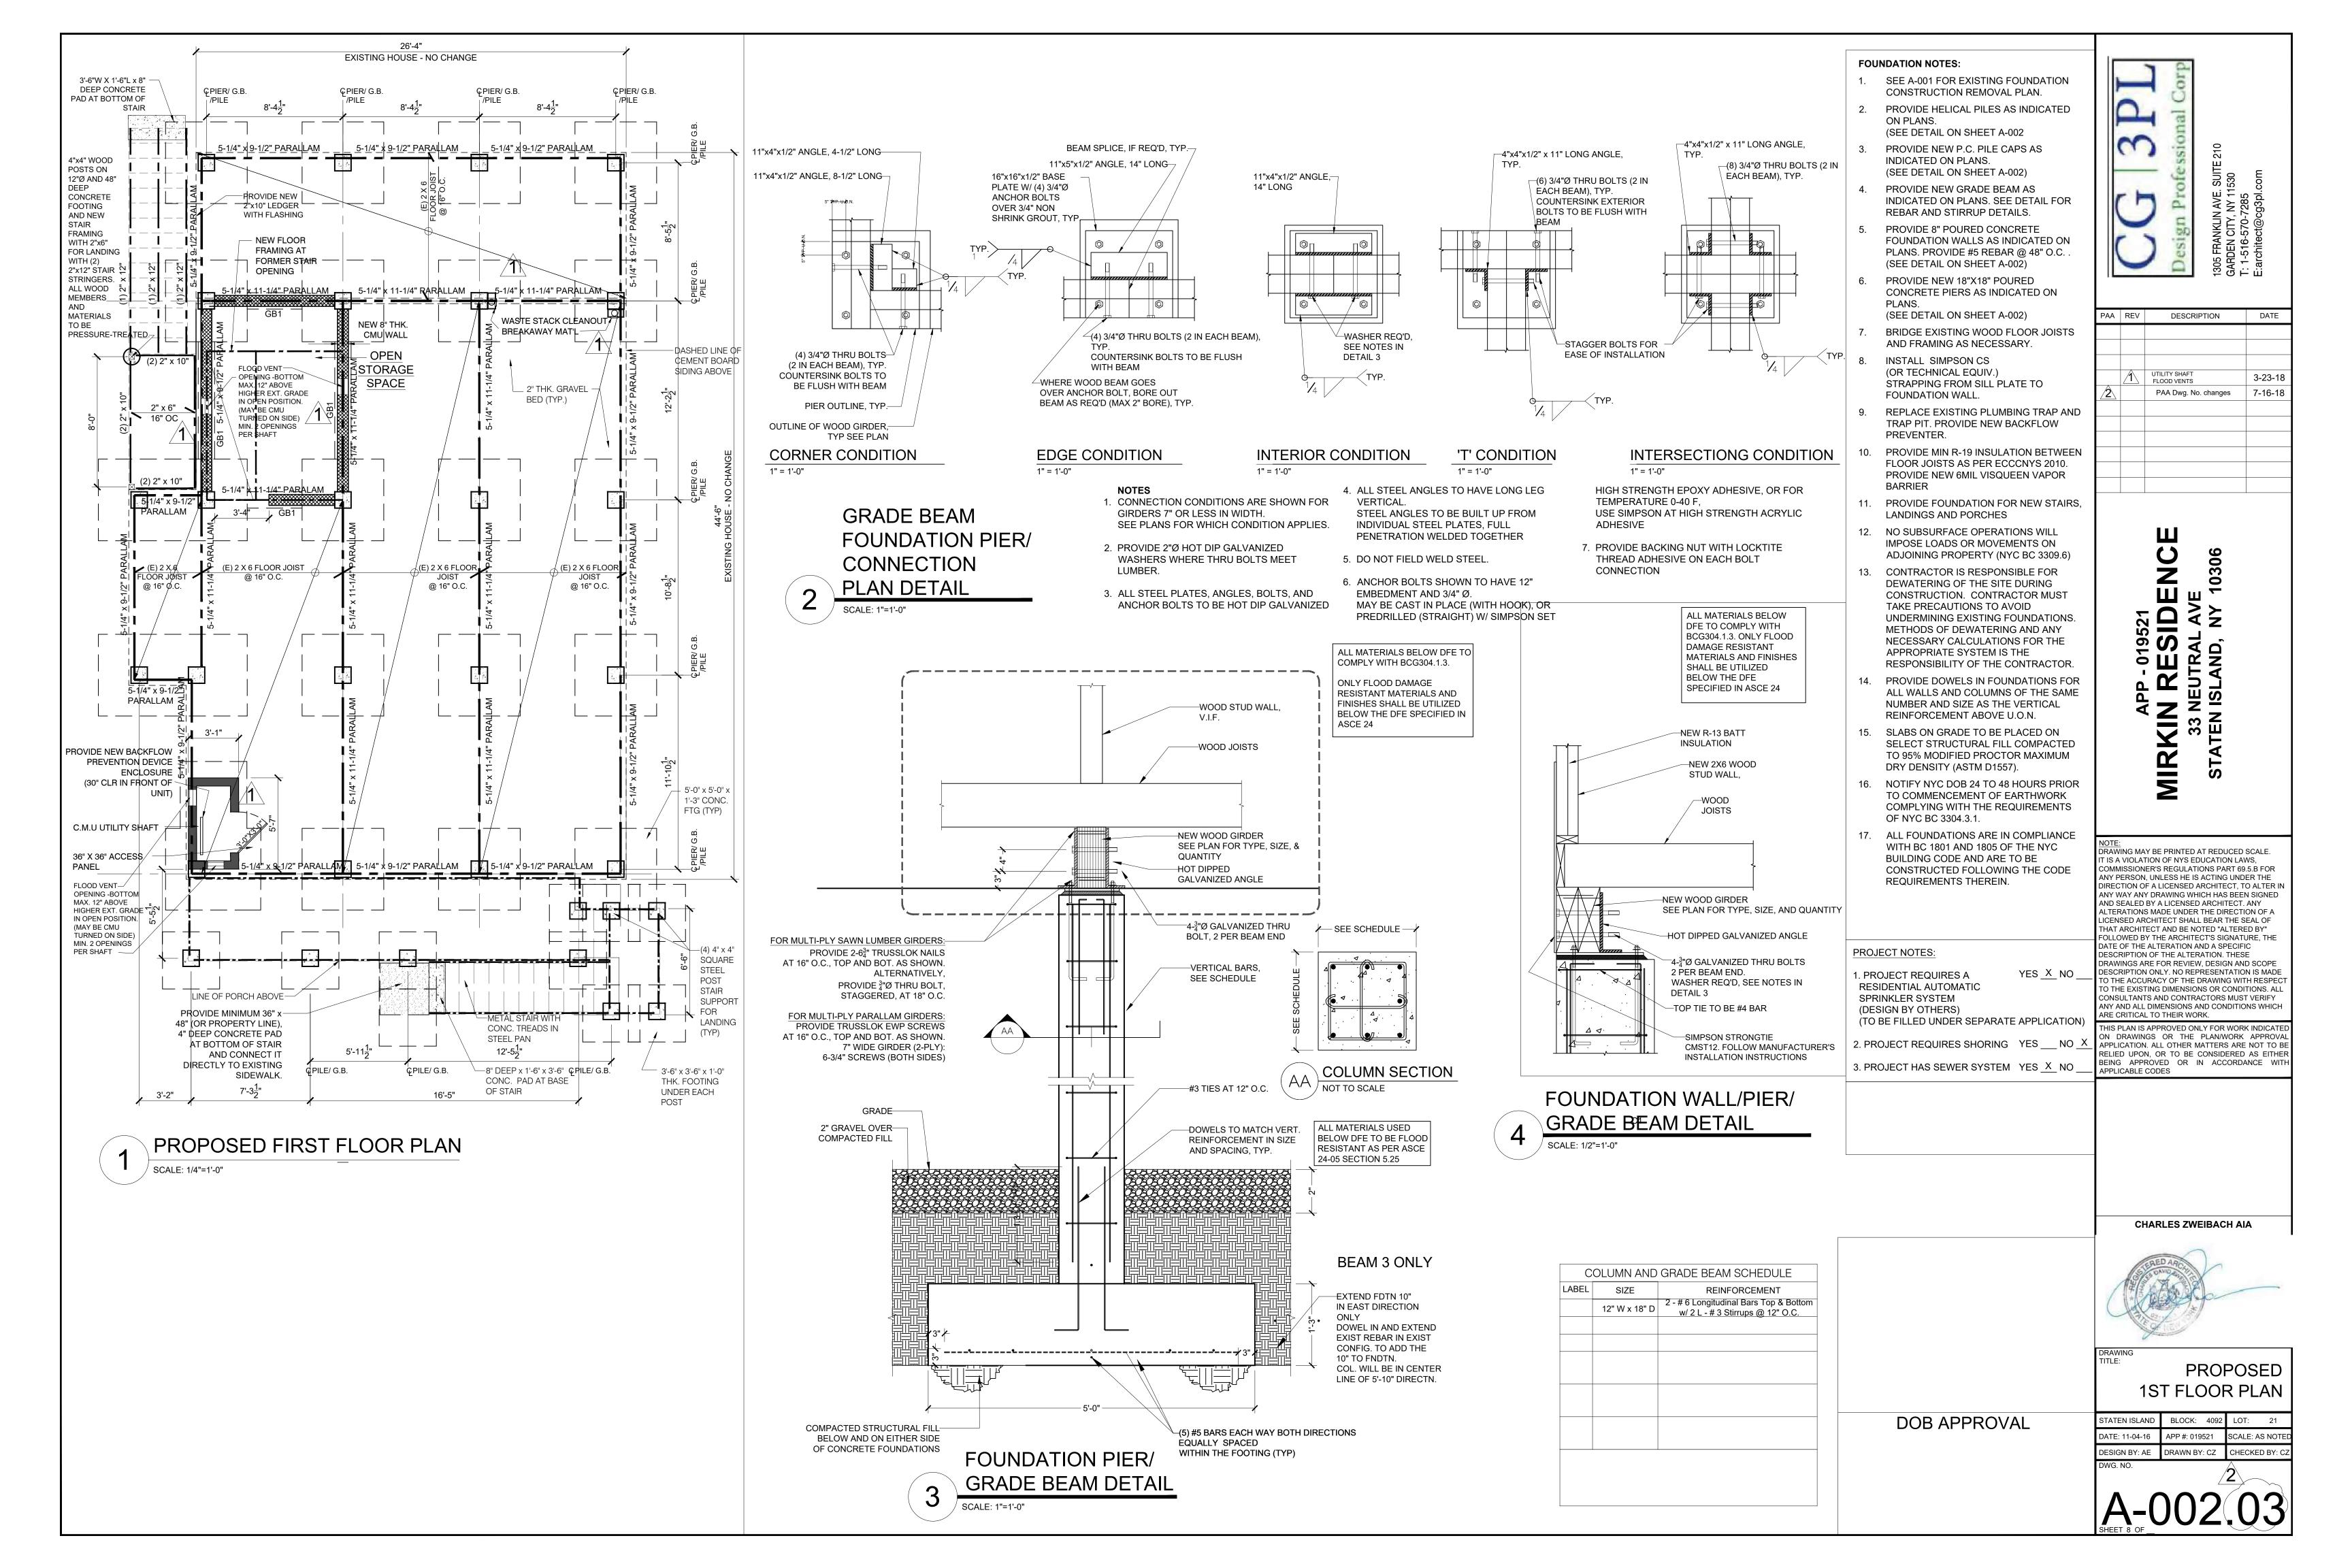
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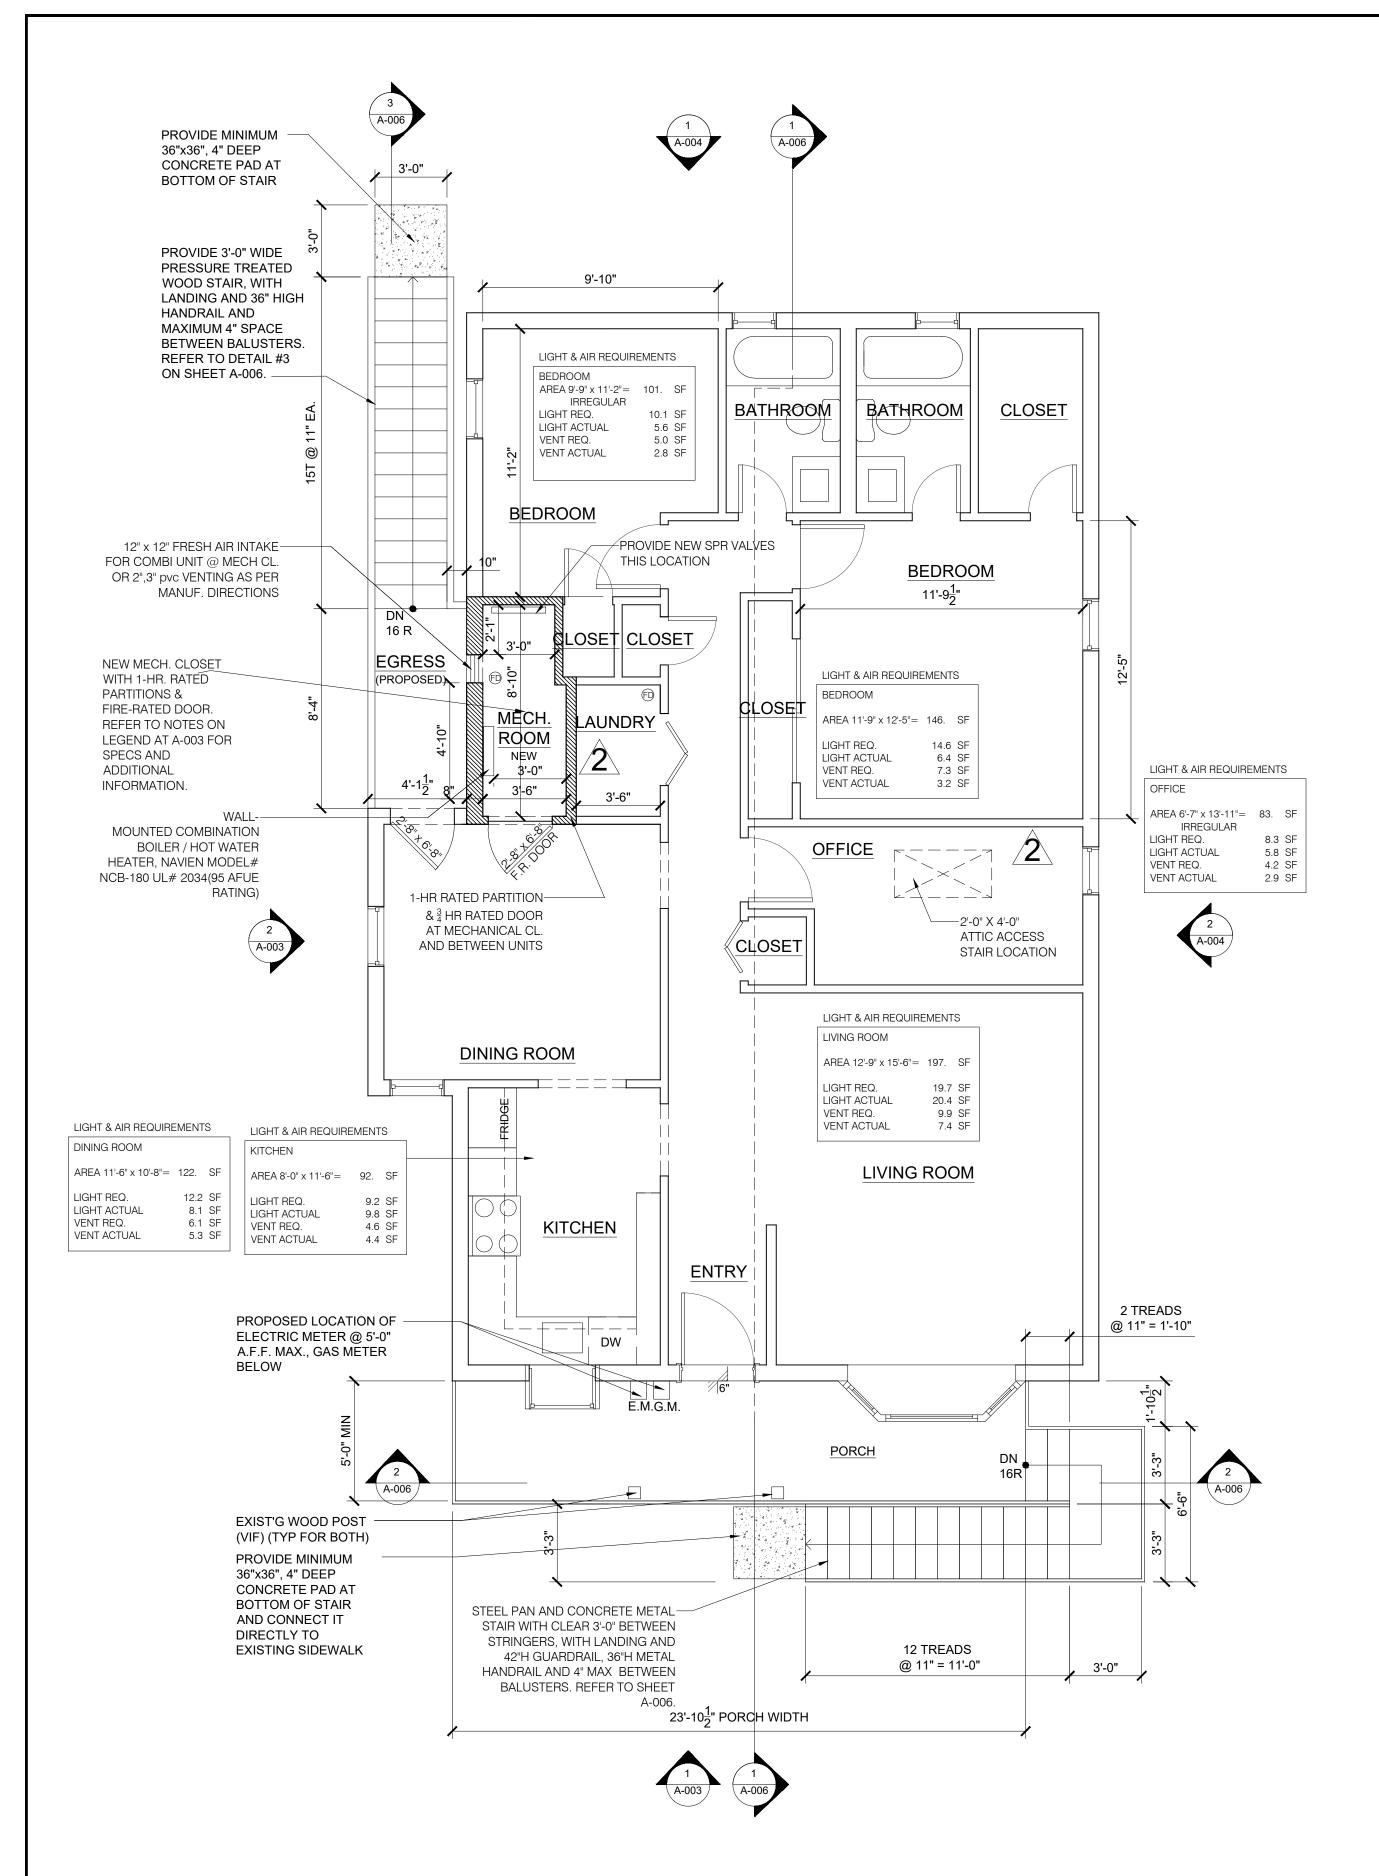


ZONING ANALYSIS MAPS, DRAWINGS LIST SPECIAL INSPECTIONS

STATEN ISLAND BLOCK: 4092 DATE: 11-04-16 APP #: 019521 SCALE: AS NOTE DRAWN BY: CZ DESIGN BY: AE CHECKED BY: C

DOB APPROVAL





PROPOSED SECOND FLOOR PLAN SCALE: 1/4"=1'-0"

TYPICAL MECHANICAL ROOM NOTES:

- 1. FOR WD. FR. FLOOR PROVIDE 1/2" CONC. BD. BY "DUROCK" (OR
- 2. FOR WD. FR. CLG. AND/OR WALLS PROVIDE (1) LAYER OF 5/8"
 TYPE "X" GYP. BD. ON EACH SIDE OF WALL (OMIT ON CONC.
- WALLS) TO COMPLY WITH UL DESIGN U305

 3. WHEN NEW, INSTALL FURANCE/BOILER AS PER MANU.
- WHEN EXIST, MECH. EQUIP. SHALL BE VERIFIED THAT IT CONFORMS TO NYC MECH. AND FUEL GAS CODE
 COMB. AIR VOLUME AS PER MANU. SPEC.'S - PROVIDE FRESH AIR
- INTAKE FROM EXTERIOR

 6. MAINTAIN OR PROVIDE FURANCE/BOILER EMERGENCY SHUT OFF
- MAINTAIN OR PROVIDE FURANCE/BOILER EMERGENCY SHUT OFF SWITCH
- FOR GAS SERVICE, PROVIDE GAS SHUT OFF SWITCH.
 PROVIDE MINIMUM 18" CLEARANCE BETWEEN BOILERS &
 ENCLOSING WALL PARTITIONS. PROVIDE 3'-0" CLEARANCE IN
 FRONT OF BOILER/ FURNACE FOR MAINTENANCE.
- PROVIDE ELECTRIC LIGHT.
 PROVIDE 12"X12" FIXED REGISTER WITH B.S.A. APPROVED TYPE
- FIRE DAMPER WITH FUSIBLE LINK.

 11. INSTALLATION OF EQUIPMENT SHALL COMPLY WITH B.S.A./ M.E.A. APPROVAL, BUILDING CODE REQUIREMENTS, DEPARTMENT OF

BUILDINGS RULES & REGULATIONS, AND MANUFACTURER'S

SPECIFICATIONS (LATEST EDITION)

TYPICAL MECHANICAL ROOM NOTE EQUIPMENT SPECS:

- ALL MECHANICAL SYSTEMS SHALL CONFORM TO THE "NYC BUILD IT BACK PROGRAM, GENERAL REQUIREMENTS AND SPECIFICATIONS, LATEST EDITION
- MECHANICAL SPECIFICATIONS PROVIDED BELOW ARE PRELIMINARY AND SHOULD BE USED FOR REFERENCE PURPOSES ONLY. FINAL SPECIFICATIONS SHALL BE CONFIRMED BY GENERAL CONTRACTOR IN FIELD. SEE FLOOR PLAN FOR SYSTEM TYPE AND EQUIPMENT.
- PROVIDE HORIZONTAL GAS-FIRED FURNICE AND AIR HANDLING UNIT WITH A MINIMUM SEER RATING OF 14 AND A MINIMUM BTU OUTPUT OF 40,000. UNIT SHALL BE SIMILAR OR EQUAL TO COMPLYING UNIT MANUFACTURED BY CARRIER.
- 4. PROVIDE DOMESTIC HOT WATER HEATER SIMILAR OR EQUAL TO GE MODEL SG40T12AVG, 40 GAL., WARRANTY: MINIMUM 7 YEARS; PROVIDE MATERIAL FOR A COMPLETE INSTALLATION. HEATER SHALL BE 240 V, HAVE CUT-OFF VALVE ON COLD WATER SUPPLY, AND A THERMAL AND PRESSURE SAFETY RELIEF VALVE. SHALL COMPLY WITH THE NEW YORK CITY BUILDING CODE.
- ALL WORK MUST CONFORM TO THE FOLLOWING CODES AND REGULATIONS ADOPTED BY ITS PARTICIPATING LOCAL GOVERNMENTS:
- a. NEW YORK CITY BUILDING CODE ("NYCBC")b. NEW YORK CITY MECHANICAL CODE ("NYCMC")
- c. NEW YORK CITY ENERGY CONSERVATION CODE ("NYCECC")

NEW SIDING NOTES:

- 1. CEMENT FIBER SIDING SHALL BE SIMILAR OR EQUAL TO LAP SIDING MANUFACTURED BY JAMES HARDIE.
- 2. SIDING SHALL BE INSTALLED AS PER MANUFACTURER'S SPECIFICATIONS AND THE NYC BUILDING CODE.
- 3. INSTALLED CEMENT SIDING SHALL CONFORM TO THE MINIMUM STANDARDS OF THE BUILD IT BACK PROGRAM.
- 4. SIDING SHALL BE INSTALLED OVER AN APPROVED WATERPROOF MEMBRANE.
- 5. FASTENERS SHALL BE CONCEALED AND JOINT FLASHING AND BASE FLASHING SHALL BE INSTALLED WHERE REQUIRED.
- 6. PROVIDE ALL NECESSARY TRIM FOR PROPER INSTALLATION.
- 7. SIDING SHALL EXTEND TO BOTTOM OF FOUNDATION GIRDERS (ON OPEN FOUNDATIONS -WHEN APPLICABLE)
- 9. PROVIDE NECESSARY SHEATHING FOR PROPER INSTALLATION

FIRE PROTECTION REQUIREMENT NOTES:

- 1. THE BUILDING SHALL HAVE A FIRE SPRINKLER SYSTEM IN ACCORDANCE WITH CHAPTER 9 AND APPENDIX Q OF THE NYC BUILDING CODE.
- 2. THE FIRE SPRINKLER SYSTEM SHALL BE DESIGNED BY OTHERS AND INSTALLED UNDER SEPARATE PERMIT.
- 3. THE BUILDING WILL BE PROVIDED WITH INTERCONNECTED SMOKE AND CARBON MONOXIDE ALARMS, DESIGNED IN ACCRODANCE WITH SECTION 907.2.11 OF THE NYC BUILDING CODE.
- 4. THE UNDERSIDE OF THE BUILDING EXTERIOR, FOR THOSE BUILDINGS NOT UTILIZING A CLOSED FOUNDATION, SHALL HAVE AN EXTERIOR ASSEMBLY THAT PROVIDES A 2-HOURS FIRE RESISTANCE RATING.
- 5. THE HEIGHT FROM GRADE PLANE TO THE HIGHEST WINDOW SILL LEADING TO A HABITABLE SPACE MAY NOT EXCEED 32 FEET.

SYMBOL LEGEND

SMOKE AND CARBON MONOXIDE COMBINATION DETECTOR - AS INDICATE ON PLANS

75 CFM BATHROOM EXHAUST FAN

---- EXISTING WALL TO BE

EXISTING WALL TO REMAIN

DEMOLISHED

NEW 1 HR RATED WALL TO MATCH EXISTING (OR OTHERWISE NOTED)

CMU WALL

EXISTING WALL
INSTALL NEW FIRE RESISTANCE
RATED 5/8" TYPE "X" GYPSUM
BOARD (1-HOUR FIRE RATED)

CONSTRUCTION PLAN NOTES:

- NEW MECHANICAL ROOM TO BE PROVIDED ON THE FIRST FLOOR.
 MECHANICAL SHALL BE ELEVATED TO THE PROPOSED D.F.E. (UNIT
 TO BE INSPECTED & VERIFIED THAT IT CONFORMS TO NYC
 MECHANICAL & FUEL & GAS CODE. PROVIDE DIRECT VENT EXHAUST
 FOR COMBUSTION AIR AS PER CODE & MANUFACTURER'S
 SPECIFICATIONS)
- PROVIDE 1-HR FIRE SEPARATION WALL AND DOOR BETWEEN MECHANICAL ROOM & ADJACENT ROOMS.
- 3. INSTALL NEW FIRE-RATED 5/8" DENSGLASS FIREGUARD TYPE "X" GYPSUM BOARD ON EXTERIOR WALLS LESS THAN 3' AWAY FROM PROPERTY LINE AS PER NYC BUILDING CODE
- 4. ALL NEW STAIRS TO HAVE A MAXIMUM 8-1/4" RISER AND MINIMUM 9"
 TREAD
- 5. STAIR RAILINGS TO HAVE VERTICAL BALUSTERS NOT MORE THAN 3 1/2" SPACE APART. 42" HIGH
- 6. ALL GLAZING WITHIN 18" OF FF TO BE TEMPERED GLASS
- SEE LANDSCAPING PLAN FOR NEW PLANTINGS AS PER SECTION CODE
- 8. CONTRACTOR IS REQUIRED TO COORDINATE ALL METER LOCATIONS WITH UTILITY (GAS, WATER, & ELECTRIC) COMPANIES & COMPLY WITH THEIR REQUIREMENTS AS WELL AS NYC BUILDING CODE & APPENDIX G REQUIREMENTS.

DOOR & WINDOW NOTES:

- ALL EXTERIOR DOORS & WINDOWS SHALL BE FLASHED AND OPENINGS SEALED TO PREVENT WATER AND AIR INFILTRATION
- 2. GLAZED OPENINGS SHALL CONFORM TO THE APPLICABLE REQUIREMENTS OF THE NYECC LATEST EDITION.

LIGHTING AND ELECTRICAL NOTES

3. WINDOW OPENINGS IN SLEEPING ROOMS SHALL CONFORM TO THE CLEAR OPENING WIDTH, OPENING AREA AND SILL HEIGHT REQUIREMENTS OF THE NYC BUILDING CODE

REQUIREMENTS OF THE NYC BUILDING CODE.

- 1. PROVIDE SWITCH CONTROLLED CEILING MOUNTED LIGHTING FIXTURES OR CEILING
- FANS IN LIVING ROOM AND BEDROOMS AS SELECTED BY OWNER

 2. PROVIDE 3-WAY SWITCHED WIRING AT TOP AND BOTTOM OF INTERIOR STAIRS, AND AT LOCATIONS AS REQUIRED BY CODE.
- 3. ALL HALLWAYS SHALL BE PROVIDED WITH CEILING MOUNTED FIXTURE(S) WITH 3-WAY SWITCHES.
- ALL EXTERIOR LIGHT FIXTURES SHALL BE SWITCH CONTROLLED FROM INTERIOR.
 PROVIDE SELF REGULATING HEAT TRACE ON ALL PIPING SUBJECT TO FREEZING.
- PROVIDE CABLE TV WIRING TO LIVING ROOM AND BEDROOMS.
 WHERE THE PROJECT PROPOSES INSTALLATION OF A GENERATOR HOOK-UP TO PROVIDE EMERGENCY POWER, PROVIDE MANUAL INDOOR 6-CIRCUIT GENERATOR
- LOCATED BELOW STRUCTURE.

 8. PROVIDE DOOR BELLS AT FRONT ENTRY DOOR.
- 9. PROVIDE EXTERIOR GFI RECEPTACLES AT FRONT AND REAR OF STRUCTURE

TRANSFER SWITCH WITH REMOTE POWER INLET BOX, REMOTE INLET BOX TO BE

Design Profession 1305 FRANKLIN AVE. SUITE 210

PAA	REV	DESCRIPTION	DATE
	1	COMBO BOILER	9-13-17
<u>^</u> 2		ATTIC ACCESS STAIR	3-29-18
<u>^</u> 2		MECH RM EQUIP LOCATION	3-29-18
<u>3</u>		PAA Dwg. No. changes	7-16-18
			·

MIRKIN RESIDENCE 33 NEUTRAL AVE STATEN ISLAND, NY 10306

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CHARLES ZWEIBACH AIA



PROPOSED 2ND FLOOR PLAN

DOB APPROVAL


STATEN ISLAND BLOCK: 4092 LOT: 21

DATE: 11-04-16 APP #: 019521 SCALE: AS NOTED


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DWG. NO.

A-003.03



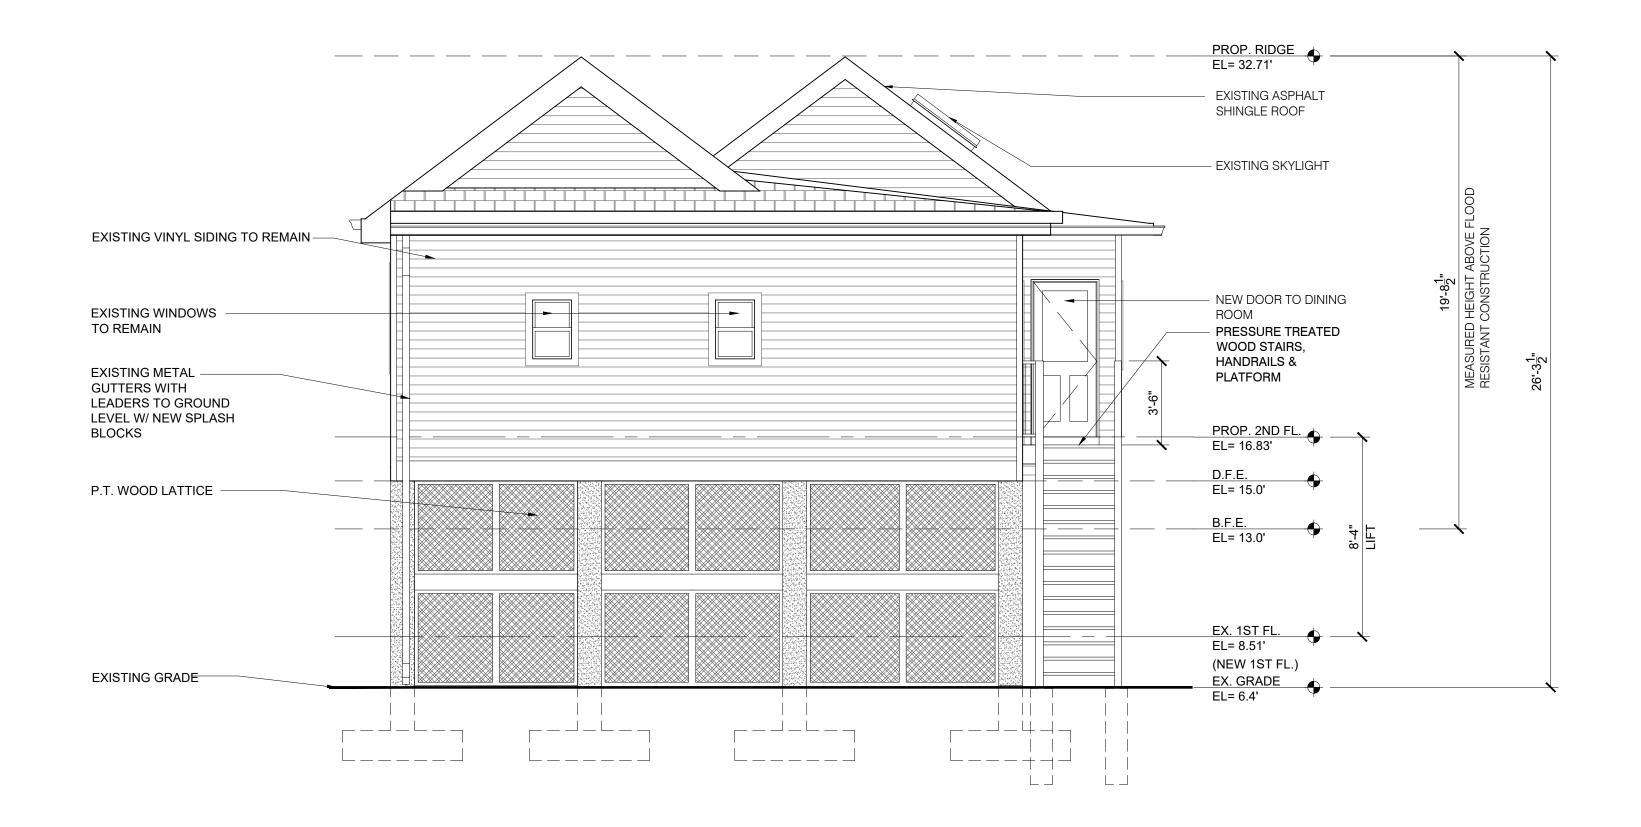

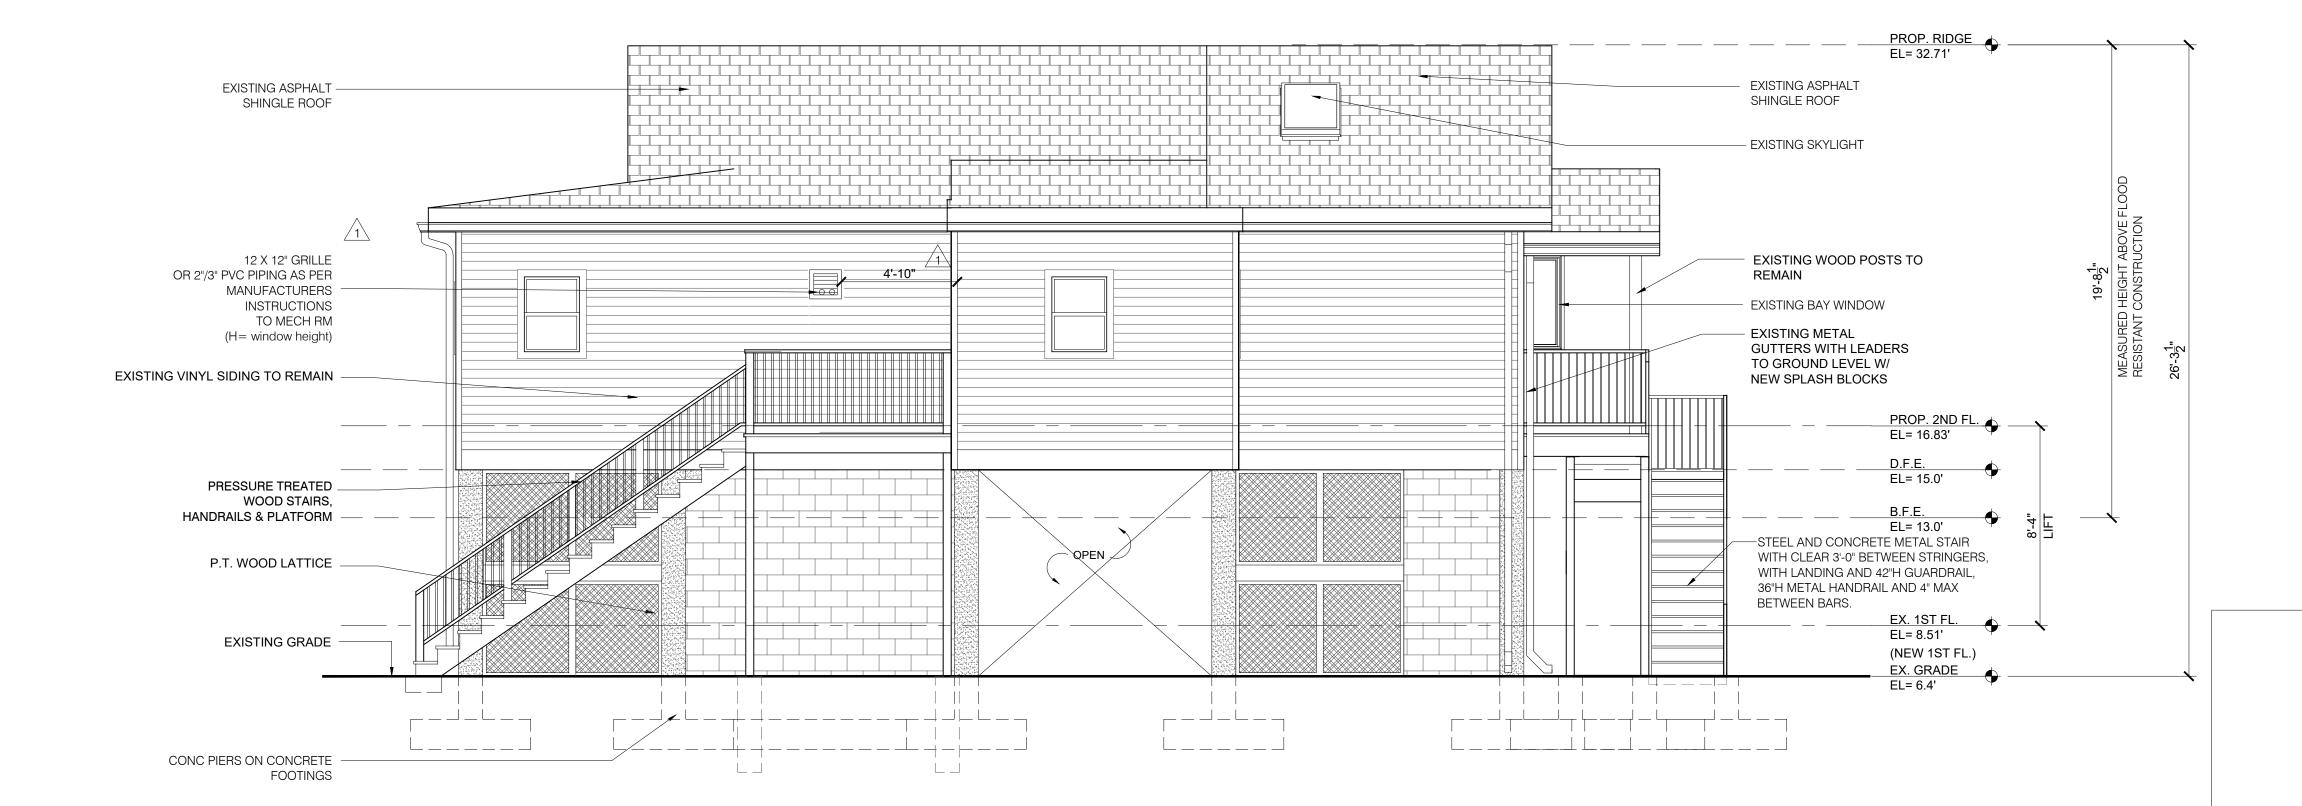

PROPOSED SIDE (NORTHWEST) ELEVATION

SCALE: 1/4"=1'-0"



PAA	REV	DESCRIPTION	DATE
À		COMBO BOILER	9-13-17
<u>^2</u>		PAA Dwg. No. changes	7-16-18

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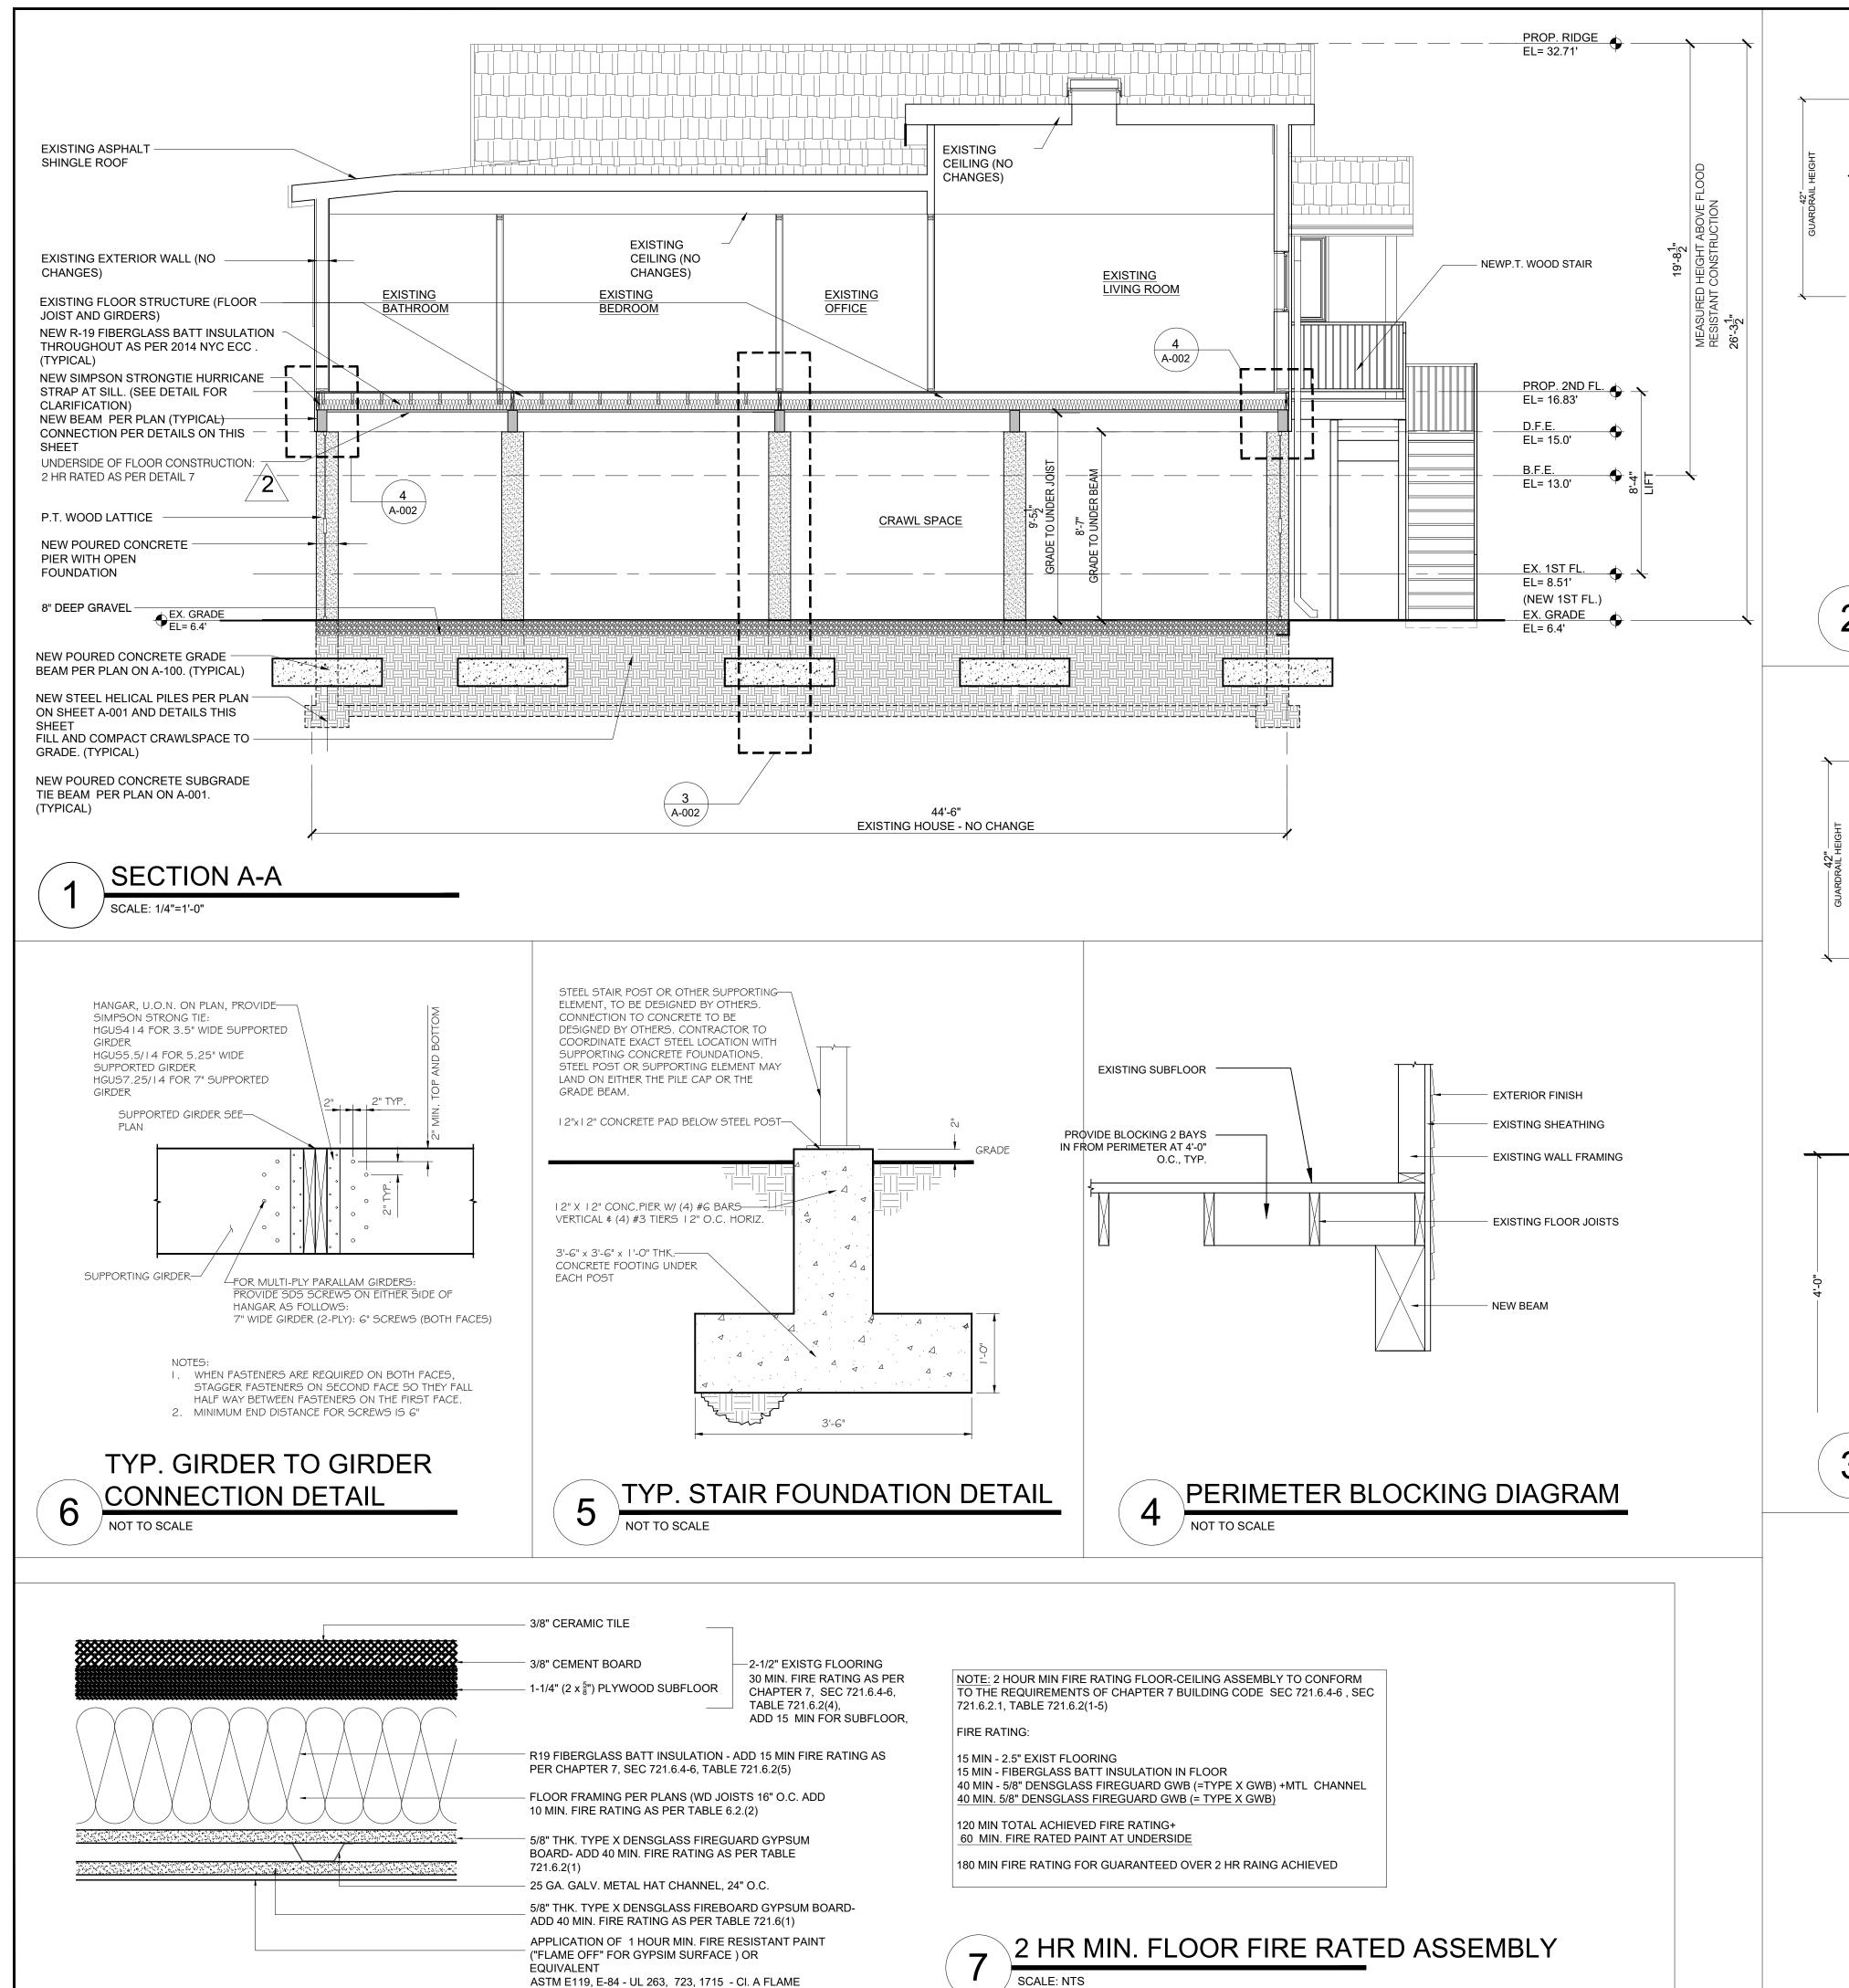


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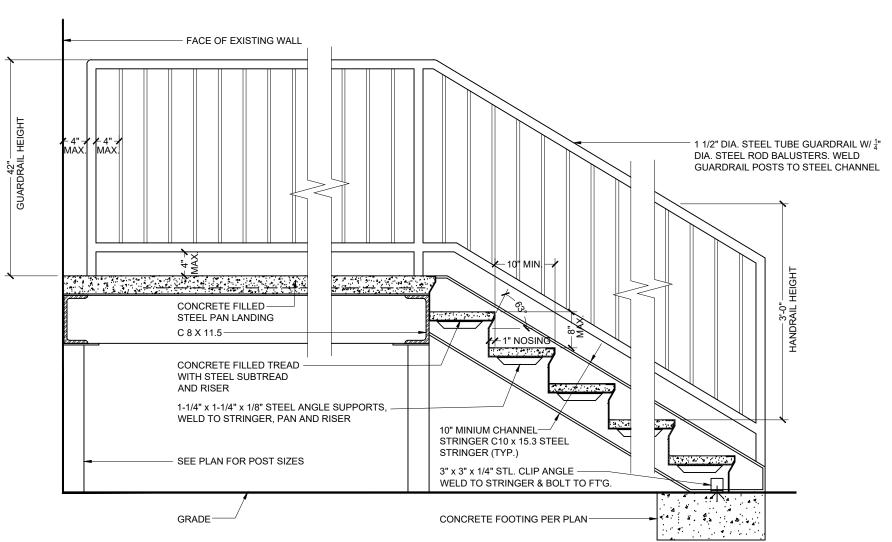
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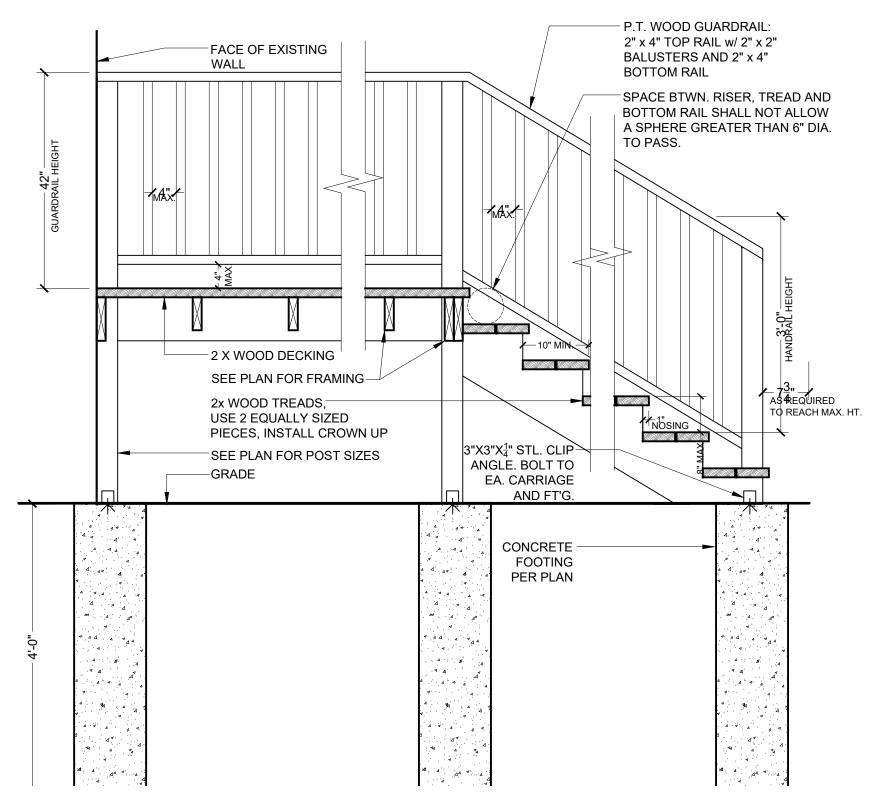
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SPREAD APPLIED UNIFORMLY AT UNDERSIDE OF GWB



TYP. STEEL & CONCRETE STAIR DETAIL



TYP. WOOD STAIR DETAIL

CG 3PL
Design Professional Corp

PAA	REV	DESCRIPTION	DATE
	1	UTILITY SHAFT FLOOD VENTS	3-23-18
2		2 HR FIRE RATING DETAIL	3-31-18
<u>^3</u>		PAA Dwg. No. changes	7-16-18

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PROPOSED SECTIONS & DETAILS


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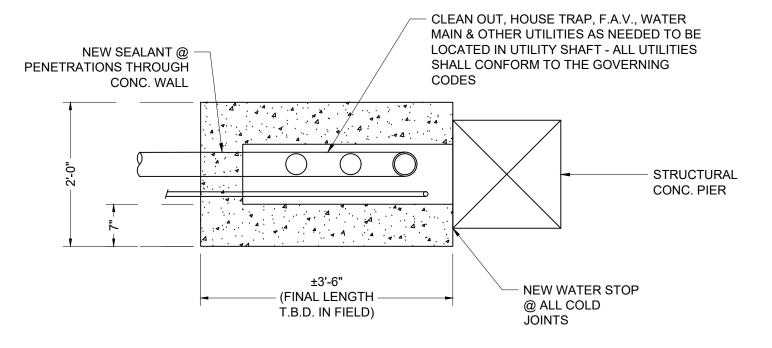
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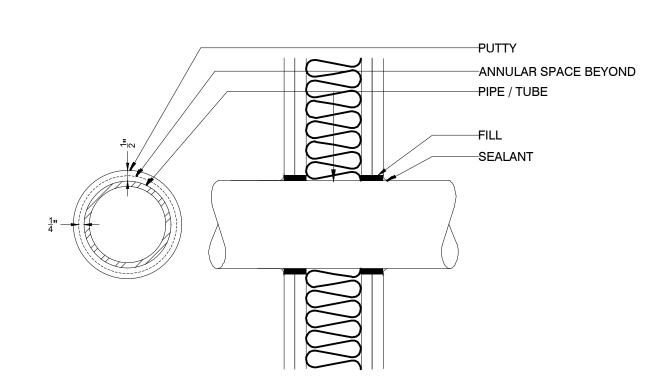
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DOB APPROVAL






UTILITY SHAFT DETAIL

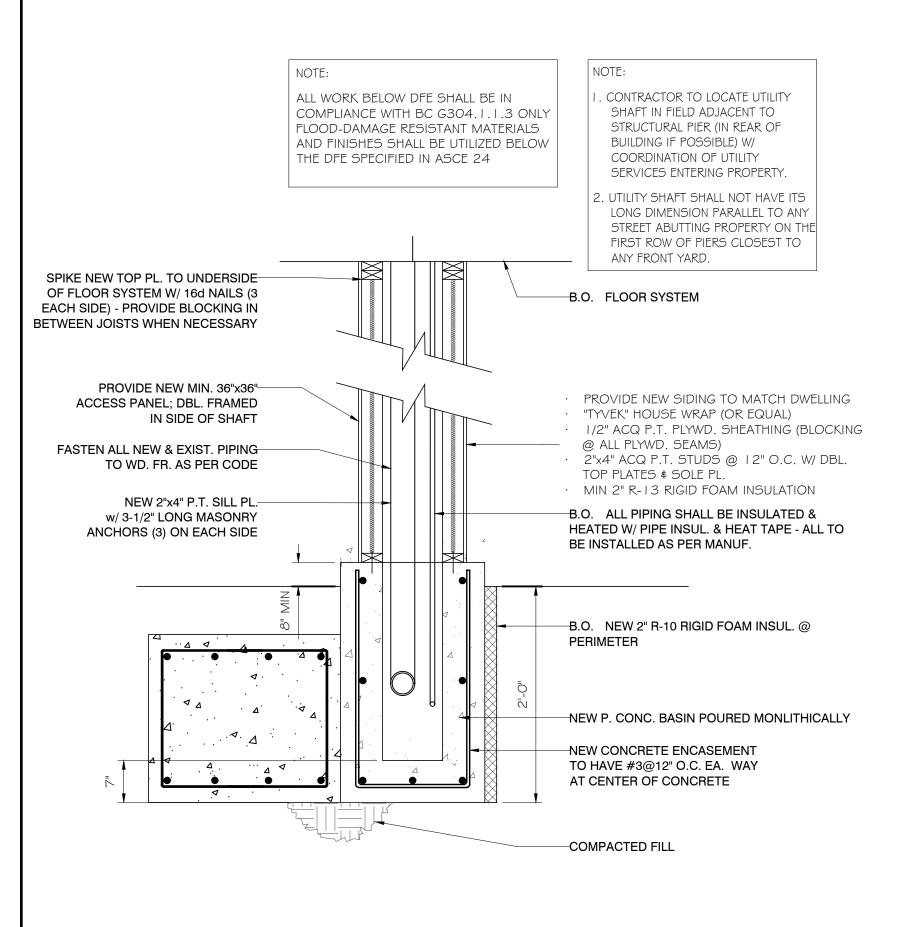

- I. DAM OF CIRCULAR OPENING CUT THROUGH GYPSUM WALLBOARD ON EACH SIDE OF WALL ASSEMBLY TO BE MIN 1/4" MIN. TO 1/2" MAX. LARGER THAN OUTSIDE DIAMETER OF PENETRATION
- 2. ANNULAR SIZE: NOM 1/4" MAX. 3. STEEL PIPE - NOM 12" DIA (OR SMALLER) SCHEDULE 10 (OR HEAVIER)
- 4. IRON PIPE NOM I 2" DIA (OR SMALLER) CAST OR DUCTILE IRON PIPE
- 5. CONDUIT NOM 6" DIA (OR SMALLER) STL ELC METALLIC TUBING OR STL CONDUIT
- 6. COPPER TUBING NOM 6" DIA (OR SMALLER) TYPE L (OR HEAVIER) COPPER TUBING 7. COPPER PIPE - NOM 6" DIA (OR SMALLER) REGULAR (OR HEAVIER) COPPER PIPE
- 8. SEALANT FILL MATERIAL TO BE FORCED INTO THE ANNULUS TO MAXIMUM EXTENTPOSSIBLE
- ADDITIONAL FILL MATERIAL TO BE INSTALLED SUCH THAT A MIN. 1/2" CROWN IS FORMED AROUND THE PENETRATING ITEM LAPPING 1/4" BEYOND THE PERIPHERY OF THE OPENING

THROUGH-PENETRATION FIRESTOP @ VERT./HORIZ. PARTITION, 2-HR ASSEMBLY NOT TO SCALE


UL SYSTEM W-L-1211

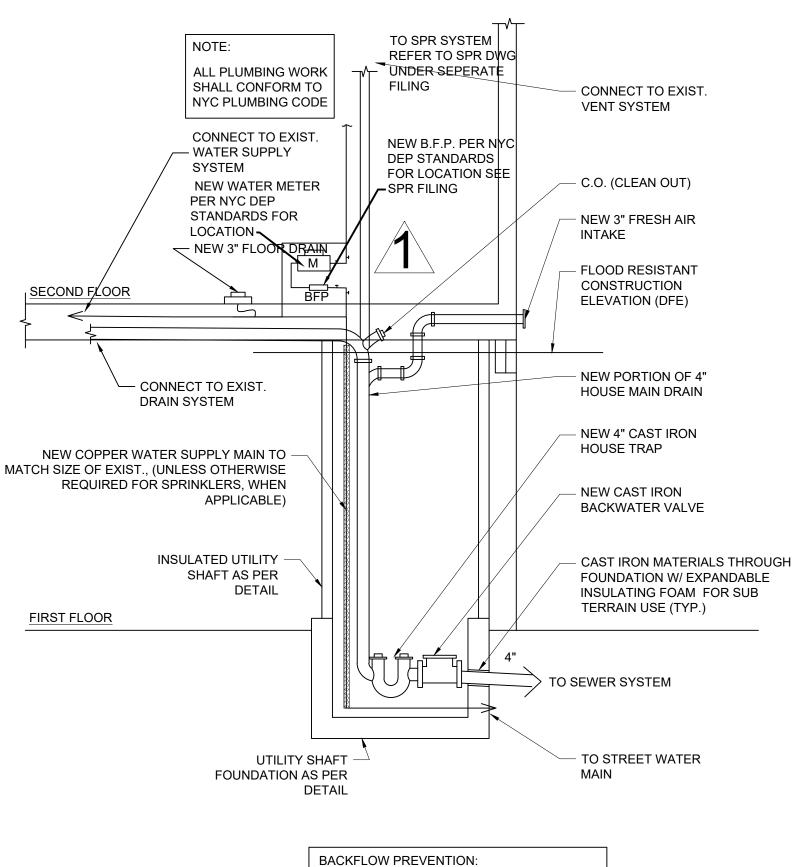

PLUMBING RISER - DRAIN / WASTE / VENT / SUPPLY NOT TO SCALE

PROVIDE BACKFLOW PREVENTION MINIMUM

10 FEET FROM WATER METER

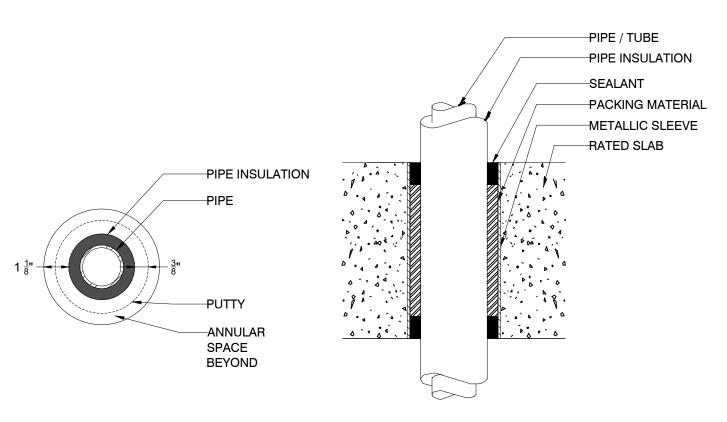


- I. METALLIC SLEEVE: (OPTIONAL) NOM 8" DIA (OR SMALLER) SCHEDULE 40 (OR HEAVIER) STEEL PIPE. CAST OR GROUTED INTO FLOOR, FLUSH WITH FLOOR OR WALL SURFACES. INSIDE DIA OF SLEEVE TO BE I 1/2" TO 2" LARGER THAN OUTSIDE DIA OF INSUL. PIPE
- 2. PIPE: NOM 4" DIA (OR SMALLER) TYPE L (OR HEAVIER) COPPER PIPE OR SCHEDULE 10 (OR HEAVIER) STEEL PIPE CENTERED IN THE OPENING AND RIGIDLY SUPPORTED ON BOTH SIDES OF
- 3. PIPE COVERING: MAX I "THICK HOLLOW CYLINDRICAL HEAVY DENSITY (MIN 3.5 PCF) GLASS FIBER UNITS HACKETED ON THE OUTSIDE WITH AN ALL SERVICE JACKET
- 4. PACKING MATERIAL: MIN 4 PCF MINERAL WOOL BATT INSULATION FIRMLY PACKED INTO ANNULAR SPACE AS A PERMANANT FORM. PACKING MATERIAL TO EXTEND THROUGHOUT THICKNESS OF FLOOR OR WALL ASSEMBLY EXCEPT FOR A MIN I" RECESS ON EACH SIDE OF THE FLOOR ASSEMBLY

UL SYSTEM C-BJ-5007

5. SEALANT: APPLIED TO FILL THE ANNULAR SPACE TO A AMIN DEPTH OF I " FLUSH WITH BOTH SURFACES OF FLOOR ASSEMBLY. ADDITIONAL MATERIAL TO BE APPLIED TO COVER EDGE OF SLEEVE \$ TO LAP APPROX. 3/4" ONTO FLOOR OR WALL SURFACE ON EACH SIDE OF ASSEMBLY

THROUGH-PENETRATION FIRESTOP @ CONC. FLOOR, 2-HR ASSEMBLY NOT TO SCALE

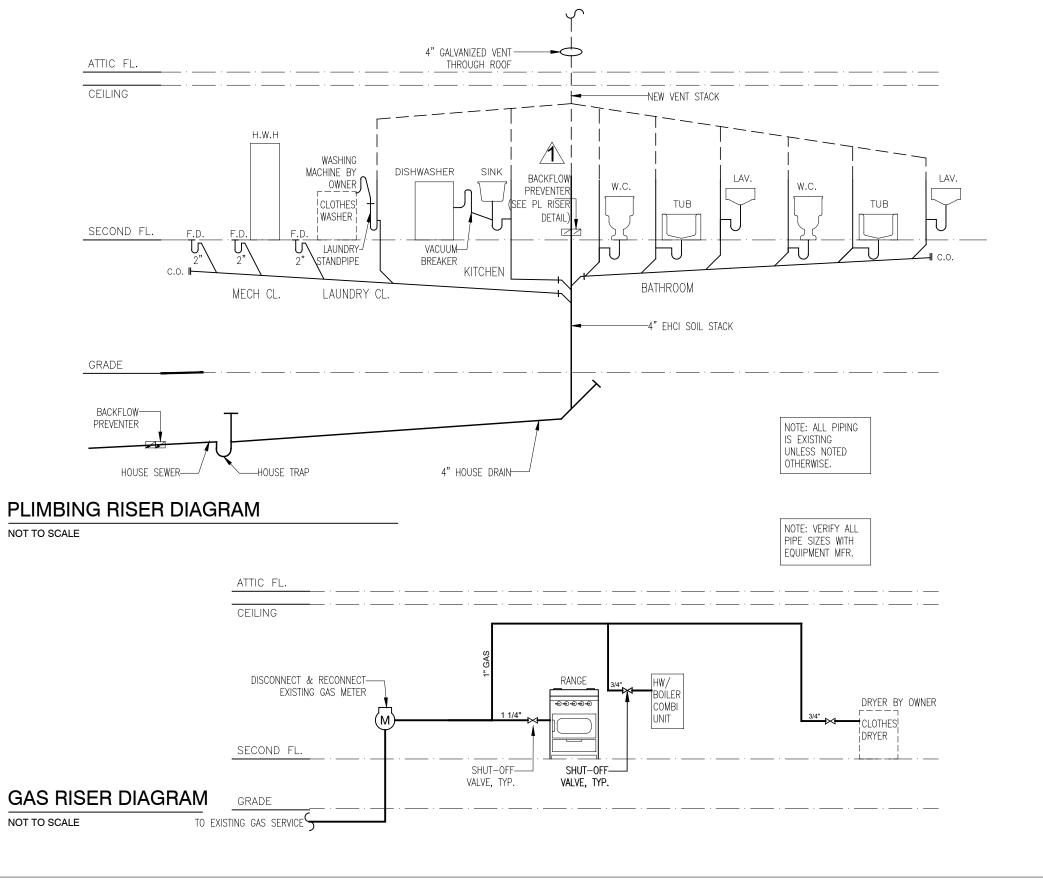

NEW YORK CITY BUILDING DEPARTMENT PLUMBING NOTES

THE PLUMBING SYSTEMS (SANITARY, WASTE, VENT, WATER DISTRIBUTION AND GAS) AND ALL ASSOCIATED EQUIPMENT WILL BE INSTALLED AND MAINTAINED IN ACCORDANCEWITH THE FULL REQUIREMENTS OF THE NEW YORK CITY 2008 PLUMBING CODE.

- THE SANITARY SYSTEM SHALL BE PROVIDED IN FULL ACCORDANCE WITH THE GENERAL PROVISIONS OF SECTION PC301.
- 2. THE MATERIALS USED IN THE PLUMBING SYSTEMS WILL BE PROVIDED IN FULL ACCORDANCE WITH SECTIONS PC302 AND PC303.
- EQUIPMENT HOOK-UP AND THE JOINING WILL BE FULL COMPLIANCE WITH SECTIONS PC605 AND PC705.
- 4. THE INSTALLATION OF FIXTURES WILL BE IN FULL ACCORDANCE WITH PC CHAPTER 4.
- 5. TRAPS FOR FIXTURES AND DRAIN LINES WILL BE PROVIDED AND CLEANOUTS INSTALLED IN FULL COMPLIANCE WITH SECTIONS PC412, PC708 AND PC CHAPTER 10.
- 6. VERTICAL AND HORIZONTAL PIPING WILL BE HUNG AND SUPPORTED AS DIRECTED IN SPECIFICATIONS AND WITH THE FULL COMPLIANCE WITH SECTION PC308.
- 7. THE WATER SUPPLY SYSTEMS OF THE SUBJECT BUILDING SHALL BE INSTALLED AND MAINTAINED IN FULL COMPLIANCE WITH PC CHAPTER 6.
- 8. THE SANITARY DRAINAGE SYSTEM WILL BE SIZED AND INSTALLED IN FULL COMPLIANCE WITH PC CHAPTER 7.
- 9. THE VENT PIPING FOR THE SANITARY DRAINAGE SYSTEM OF THE SUBJECT BUILDING WILL BE INSTALLED IN FULL COMPLIANCE WITH SECTION PC702 & PC CHAPTER 9.
- 10. THE STORM DRAINAGE SYSTEM AND PIPING WILL BE INSTALLED IN FULL COMPLIANCE WITH PC CHAPTER 11. 11. GAS PIPING AND EQUIPMENT WILL BE INSTALLED IN FULL COMPLIANCE WITH THE NEW YORK CITY FUEL GAS CODE.
- 12. ALL TRENCHING SHALL BE DONE IN ACCORDANCE WITH THE REQUIREMENTS OF SECTION PC306.
- 13. RAT PROOFING SHALL BE IN ACCORDANCE WITH SECTION PC304.
- 14. TEMPORARY TOILET FACILITIES SHALL BE PROVIDED FOR WORKMAN AS PER SECTION PC311.

MECHANICAL, ELECTRICAL, AND PLUMBING NOTES

- 1. ALL NEW PLUMBING TO COMPLY WITH 2014 NYC PLUMBING CODE.
- 2. CONTRACTOR SHALL INSTALL WATER SUPPLY, DRAIN, WASTE, AND VENT (DWV) SYSTEMS TO NYC PLUMBING CODE AND NYC DEP REGULATIONS.
- 3. PROVIDE HOT AND COLD SHUT OFF VALVES AT ALL FIXTURES.
- 4. ALL WATER PIPING TO HAVE CLEAN OUTS AT ALL CHANGES IN DIRECTION AND AT BASE OF VERTICAL WASTE
- 5. USE 4" CAST IRON THROUGH FOUNDATION WALL AND PITCHED AT $\frac{1}{8}$ " PER FOOT.

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6.	GENERAL TRAP AND WASTE SIZES AS FOLLOWS, U.O.N.:	DISH WASHER	2
		KITCHEN SINK	2
		LAVATORY	2
		SHOWER/TUB	2
		TOILET	4

- ALL SYSTEMS TO HAVE ONE 3" MAIN VENT STACK, INCREASED TO 4" THROUGH ROOF.
- 8. PROVIDE FROST PROOF HOSE BIBS WITH EASILY ACCESSIBLE DRAIN & DRAIN COCKS AS REQ'D. HOSE BIBS SHALL BE PROVIDED WITH BACKFLOW PROTECTION.
- WASTE FROM CLOTHES WASHERS AND LAUNDRY TUBS ARE TO BE PROVIDED WITH BACKFLOW PROTECTION.
- 10. THE WATER SUPPLY AND SANITARY SYSTEM SHALL COMPLY WITH LOCAL HEALTH DEPARTMENT STANDARDS AND REGULATIONS.
- 11. APPROVAL AND INSPECTION IS REQ'D BY LOCAL JURISDICTION PRIOR TO CONCEALMENT OF PLUMBING.
- 12. NOTCHING AND BORING OF STUDS, JOISTS, RAFTERS AS PER BUILDING CODE. NO NOTCHING AND BORING OF STRUCTURAL MEMBERS SHALL BE PERMITTED NOR ANY POTENTIAL DAMAGE THEREOF.
- 13. ALL NEWLY INSTALLED ELECTRICAL WORK OR APPLIANCES SHALL CONFORM TO CHAPTER 27 OF NYCBC & NYC ELECTRICAL CODE.
- 15. MECHANICAL AND FUEL GAS SYSTEMS SHALL COMPLY W/ THE NYC MECHANICAL CODE AND FUEL GAS CODE. FIRE SPRINKLERS, IF REQUIRED, TO BE DESIGNED BY OTHERS.

14. CONTRACTOR WILL FURNISH A FIRE UNDERWRITERS CERTIFICATE UPON COMPLETION OF WORK.



1305 FRANKLIN GARDEN CITY, N T·1-516-570-7	E:architect@cg
CRIPTION	DATE
IBO BOILER	9-13-1
RESUBMITTAL	12-18-1
METER ABOVE DFL	12-18-1
g. No. changes	7-16-1

PAA REV BFP SPR AND I

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THIS PLAN IS APPROVED ONLY FOR WORK INDICATE ON DRAWINGS OR THE PLAN/WORK APPROVA APPLICATION. ALL OTHER MATTERS ARE NOT TO BE RELIED UPON, OR TO BE CONSIDERED AS EITHER BEING APPROVED OR IN ACCORDANCE WITH APPLICABLE CODES

CHARLES ZWEIBACH AIA



TITLE: PLUMBING RISER DIAGRAMS AND **DETAILS**

DOB APPROVAL

STATEN ISLAND BLOCK: 4092 LOT: APP #: 019521 SCALE: AS NOTE DESIGN BY: AE DRAWN BY: CZ CHECKED BY: C