DESIGNED BY:

**GEO** 

NO. DATE

REVISION

CHECKED BY:

AC

## **BUILDING AREAS (GROSS SF):**

FLOOR	ROOM NAME	TANK ROOM	
	GAC ROOM	1,376 SF	
	TOTAL	1,376 SF	

### **ALLOWABLE AREA:** (TABLE 506.2)

RY ).	OCCUPANCY CLASS.	PROPOSED BLDG. AREA	ALLOWABLE AREA				
<i>,</i>	02,100.	PER STORY	X NS ☐ S1 ☐ SM				
1	F-2	1,376 SF	13,000 SF				
	F-2	135 SF	13,000 SF				
AL		1,511 SF	13,000 SF				

### **ALLOWABLE HEIGHT:**

	PROPOSED	ALLOWABLE  NS S	NOTES
BUILDING HEIGHT (FT)	35'-0" (AVERAGE ROOF HEIGHT)	40'-0"	TABLE 504.3
BUILDING HEIGHT (STORIES)	1 STORY	2 STORY	TABLE 504.4

#### OCCUPANCY LOADS: (TABLE 1004.1.2)

ROOM NAME		FUNCTION OF SPACE	OCC. LOAD FACTOR (GROSS)	PROPOSED AREA (GROSS)	OCC. LOAD
₽00R	GAC TREATMENT ROOM	MECH EQUIPMENT	300	1,376 SF	5
BSMT FLOO					
TOTAL				1,376 SF	5

### EGRESS REQUIREMENTS - NUMBER AND ARRANGEMENT OF EXITS: (REFER TO EGRESS PLAN)

OCC. LOAD	FLOOR, ROOM, OR SPACE OF EXITS 2			TRAVEL DISTANCE 3, 4			ARRANGEMENT MEANS OF EGRESS <sup>5</sup>		
	DESIGNATION	DESIGNATION			СОММ	N PATH TRAVEL DISTANCE		REQUIRED PROPOSED	
		REQUIRED	PROPOSED	ALLOWED	PROPOSED	ALLOWED	PROPOSED	DISTANCE DISTAN BETWEEN EXIT DOORS	DISTANCE
5	GAC TREATMENT ROOM	1 (OCC LOAD IS <49)	2	75'	46'	300'	65'	N/A, 1 EXIT REQ'D	N/A

<sup>1</sup>CORRIDOR DEAD ENDS (SECTION 1020.4)

- <sup>2</sup> SPACES WITH ONE EXIT OR EXIT ACCESS DOORWAY (TABLE 1006.2.1), MULTIPLE EXITS (SECTION 1006)
- <sup>3</sup> COMMON PATH OF TRAVEL (TABLE 1006.2.1)
- <sup>4</sup> EXIT ACCESS TRAVEL DISTANCE (TABLE 1017.2)
- <sup>5</sup> EXIT AND EXIT ACCESS DOORWAY CONFIGURATION (SECTION 1007)

## EGRESS REQUIREMENTS - EXIT WIDTHS: (SECTION 1005.3.2 AND 1010.1.1)

OCC. LOAD	FLOOR, ROOM, OR SPACE DESIGNATION	CAPACITY FACTOR REQUIRED PER OCC.	REQUIRED EXIT WIDTH	PROPOSED EXIT WIDTH
5	GAC TREATMENT ROOM	0.2"	32"	40" 80"

## INTERIOR FINISHES - FLAME SPREAD RATING WALL & CEILING:

	INTERIOR WALL &	GROUP	NON-SPRIN	IKLERED
	CEILING FINISH REQUIREMENTS BY OCCUPANCY		ROOMS & ENCLOSED SPACES	PROPOSED
:	(TABLE 803.3)	F-2	С	C (OR BETTER)

INTERIOR WALL AND CEILING FINISHES SHALL BE CLASSIFIED IN ACCORDANCE WITH ASTM E 84. SUCH INTERIOR FINISHES MATERIAL SHALL BE GROUP IN THE FOLLOWING CLASSES IN ACCORDANCE WITH THEIR FLAME SPREAD INDEX.

- CLASS A : FLAME SPREAD INDEX 0-25. (VERTICAL EXITS & EXIT PASSAGEWAYS)
- (EXIST ACCESS CORRIDOR & OTHER EXITWAYS)
- CLASS B: FLAME SPREAD INDEX 26-75
   CLASS C: FLAME SPREAD 76-200. (ROOMS & ENCLOSED SPACES)

# BUILDING THERMAL ENVELOPE COMPLIANCE - C402.1. GENERAL (PRESCRIPTIVE COMPLIANCE)

TABLE C402.1.3- INSULATION AND FENESTRATION REQUIREMENTS BY COMPONENT - CLIMATE ZONE 4A (NASSAU COUNTY, NY) TABLE C402.1.4 FOR SWINGING DOOR COMPLIANCE COMPONENT DESCRIPTION REQUIRED NOTES ROPOSED METAL BUILDINGS R-19 + R-11 R-32.5ci METAL BUILDING R-13 + R13ci R-9.8ci WALLS **BELOW-GRADE WALL** UNHEATED SLABS R-10 @24" R-10@24" **SWINGING** DOORS U-0.61 U-0.61

## STATEMENT OF COMPLIANCE NOTE:

. AS THE REGISTERED DESIGN PROFESSIONAL RESPONSIBLE FOR THESE PLANS, I HEREBY STATE THAT TO THE BEST OF MY KNOWLEDGE, BELIEF, AND PROFESSIONAL JUDGEMENT, THESE PLANS AND SPECIFICATIONS ARE IN COMPLIANCE WITH THE 2015 NYS ENERGY

## ALBERTSON WATER DISTRICT

EQUIPMENT ARE NOT REQUIRED TO COMPLY WITH THIS CHAPTER.

D&B ENGINEERS

ARCHITECTS, P.C.

AND

NASSAU COUNTY NEW YORK

GRANULAR ACTIVATED CARBON SYSTEM AT WELL NO. 4

CODE ANALYSIS AND GENERAL NOTES

CONTRACT NO.

5425 E: APRIL 2020

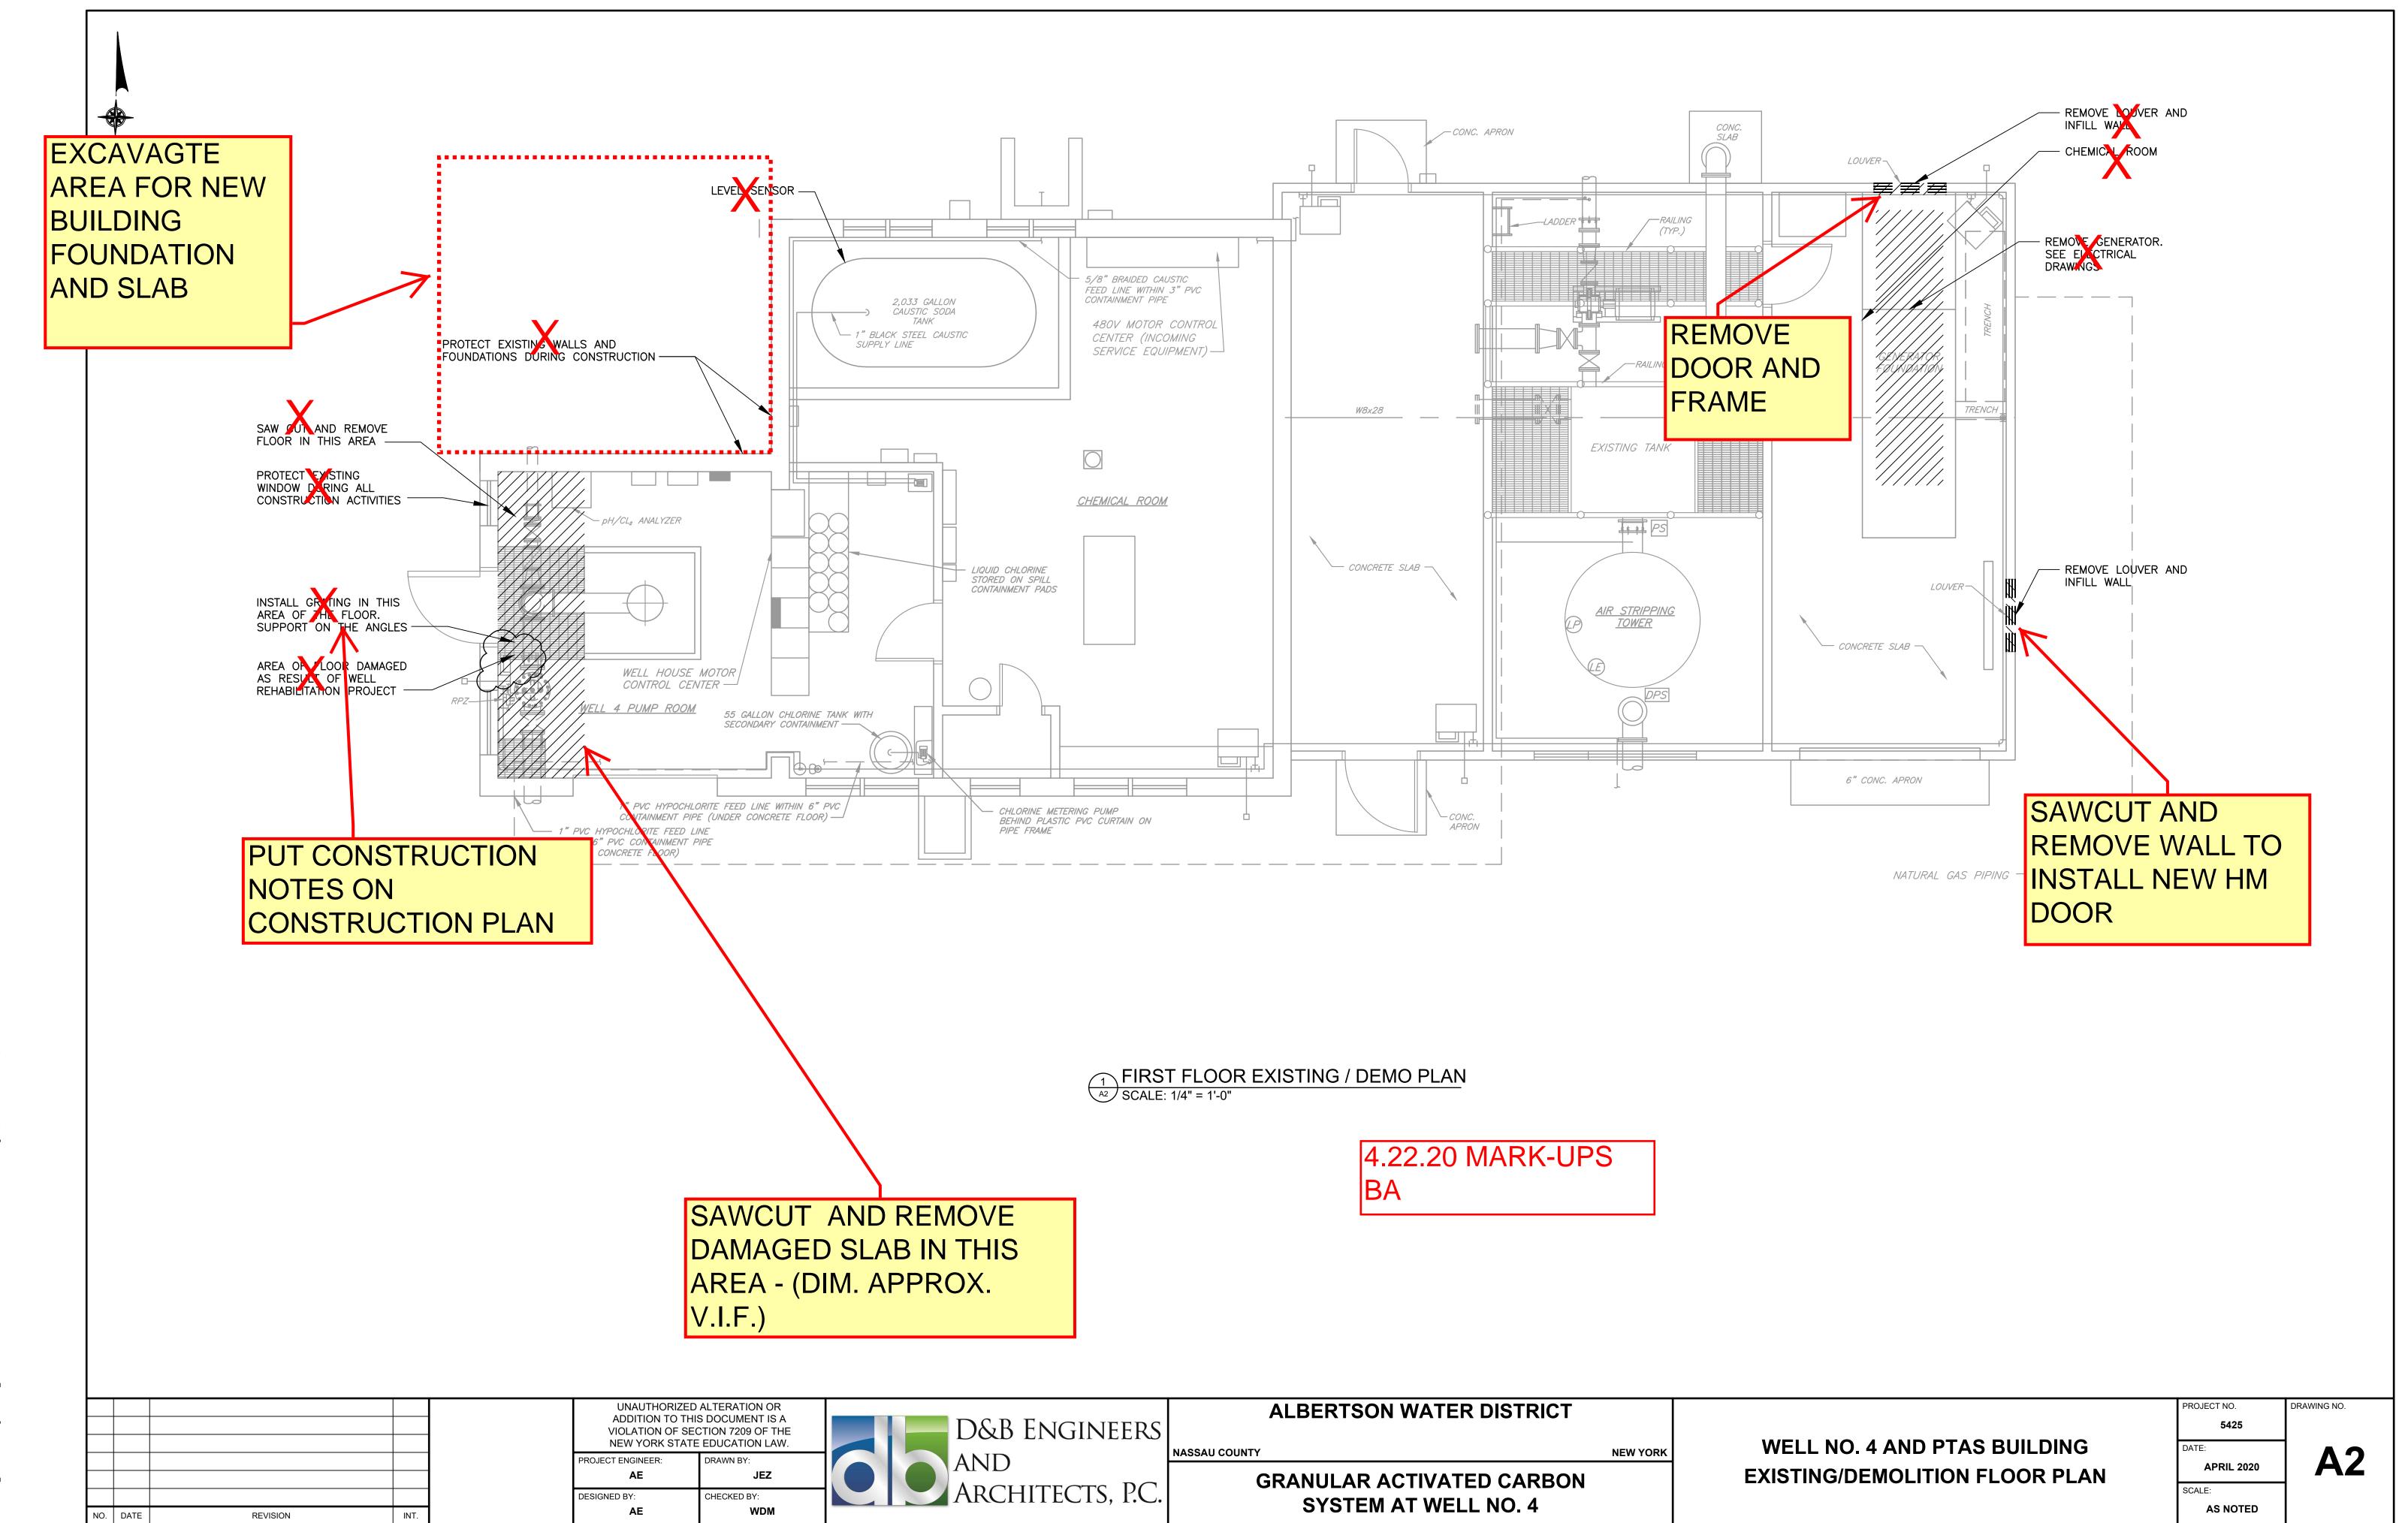
ROJECT NO.

Architectural


**A1** 

DRAWING NO.

SCALE: 1"=10'




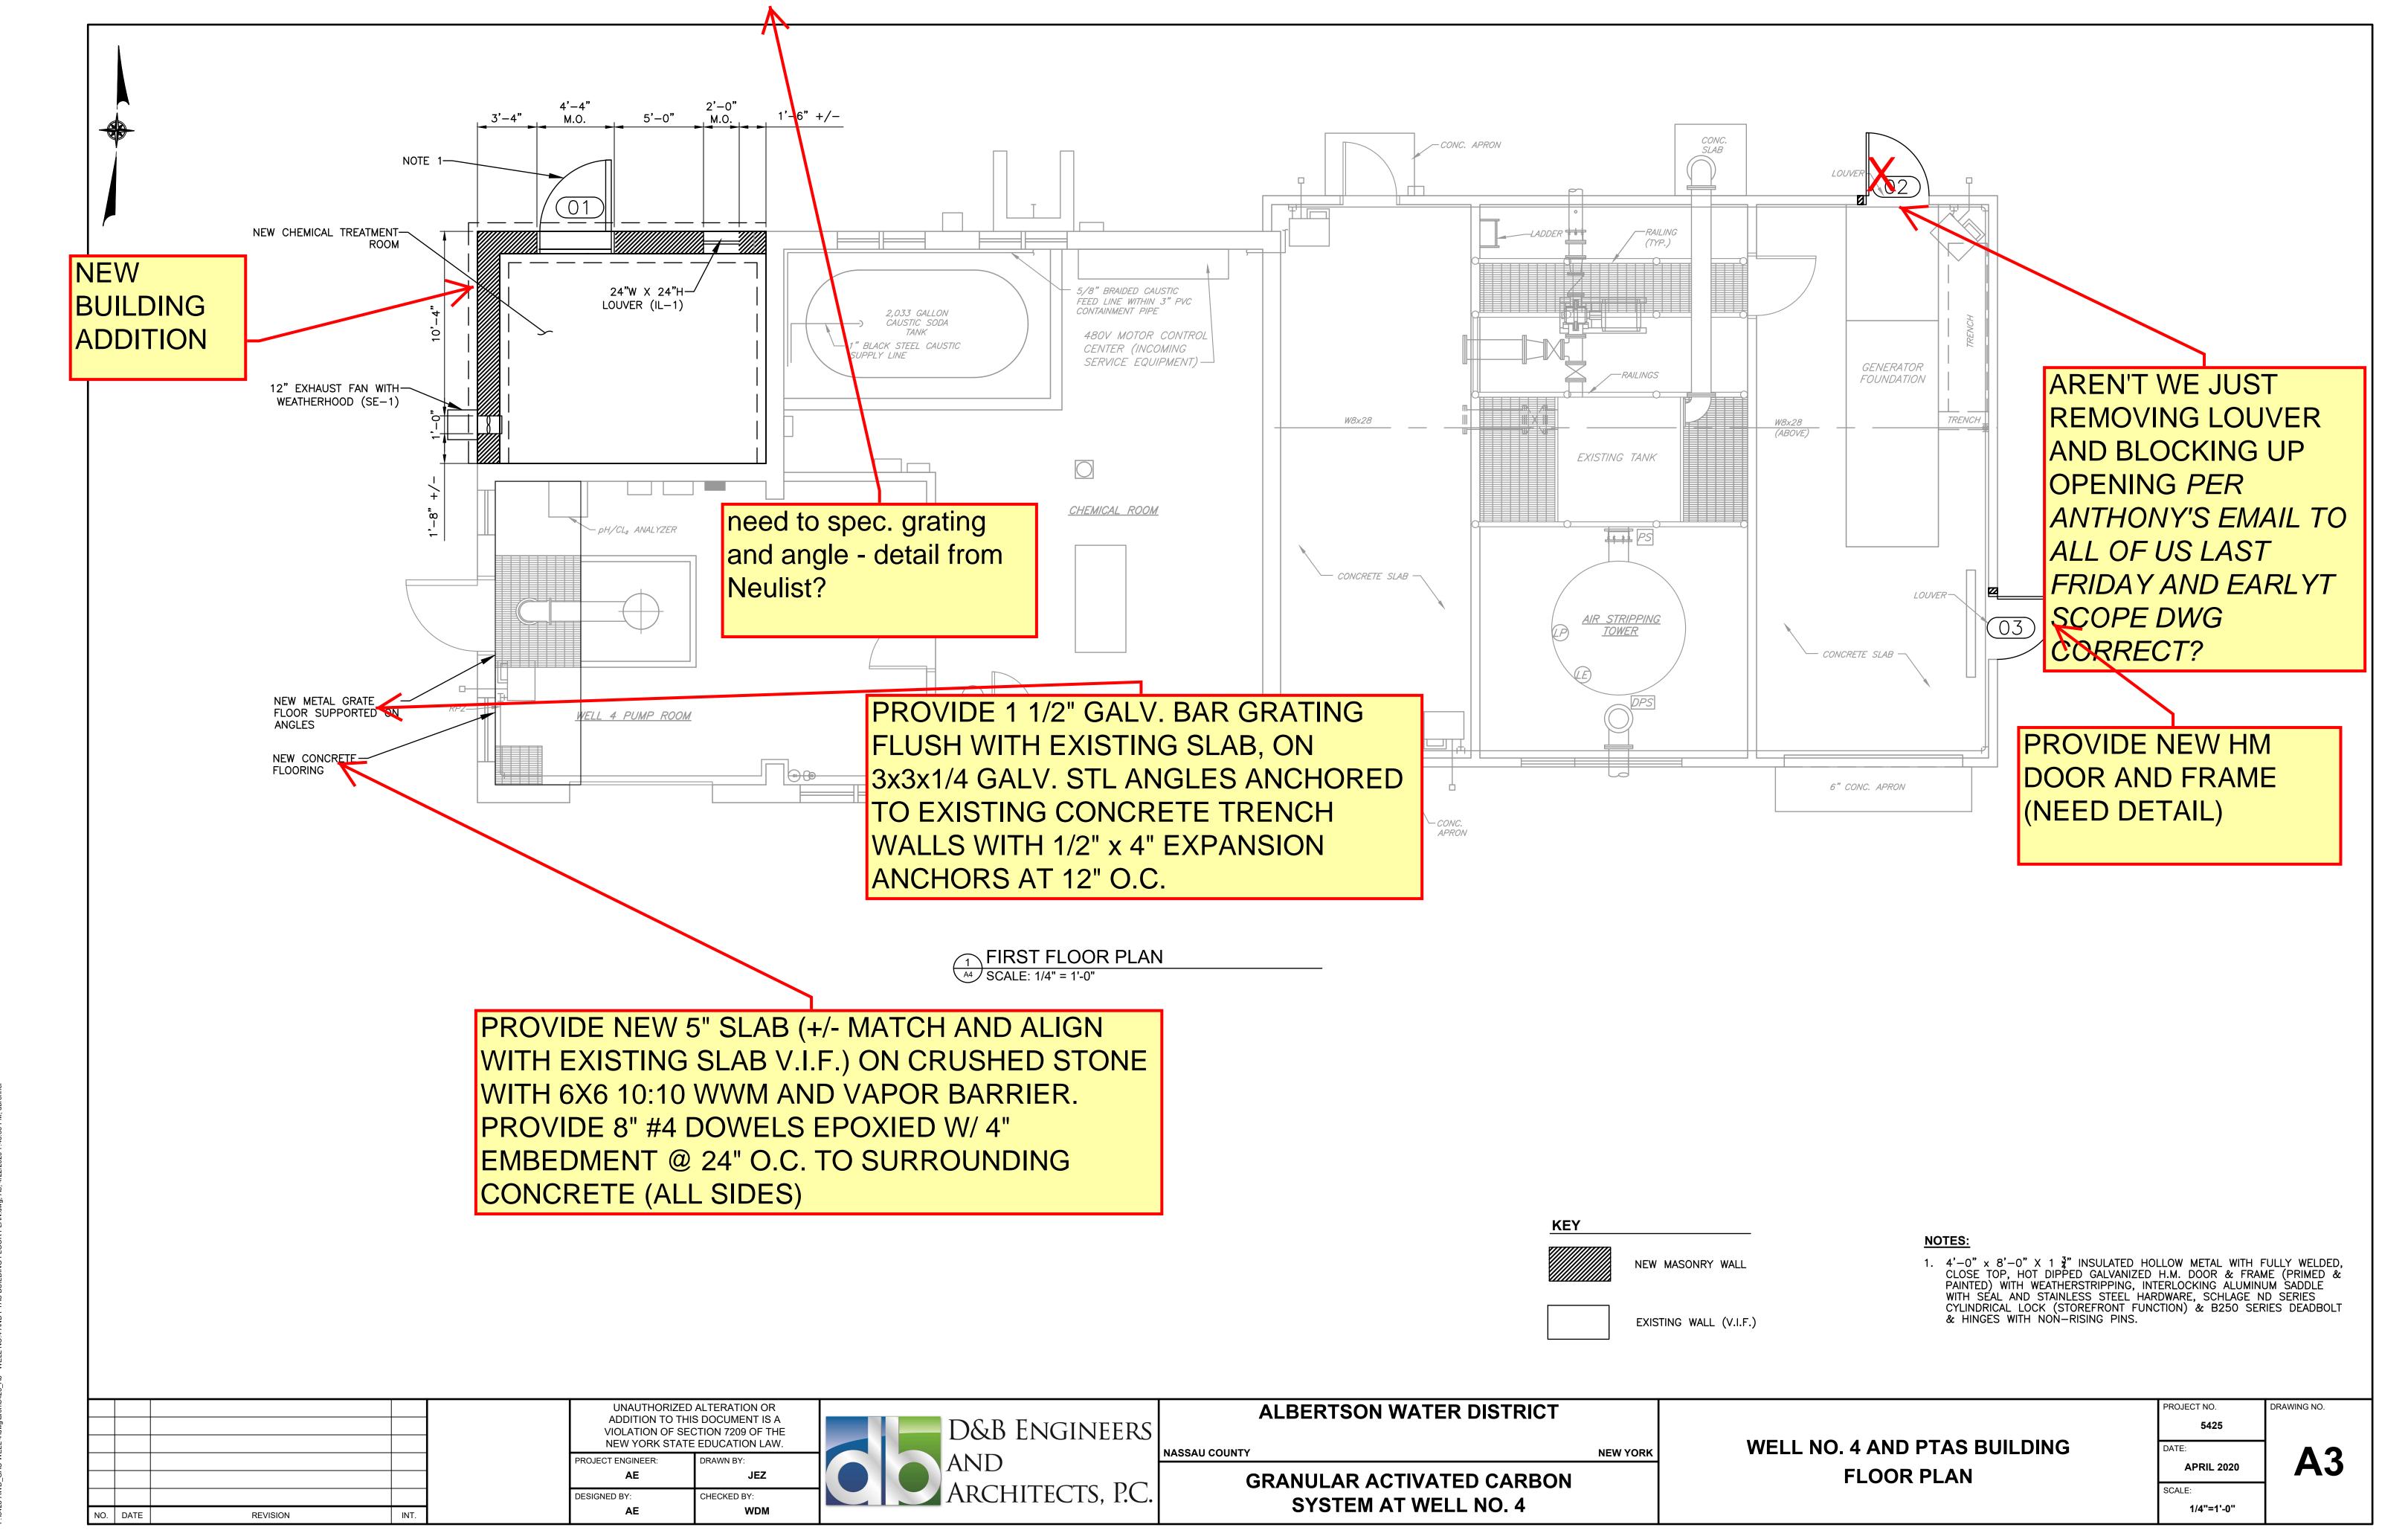425-AWD GAC-WELL 4\dwg\arch\5425 A2 - WELL NO.4 AND PTAS BUILDING EXISTING DEMO FLOOR PLAN.dwg. A2, 4/22/2020 7:43:19



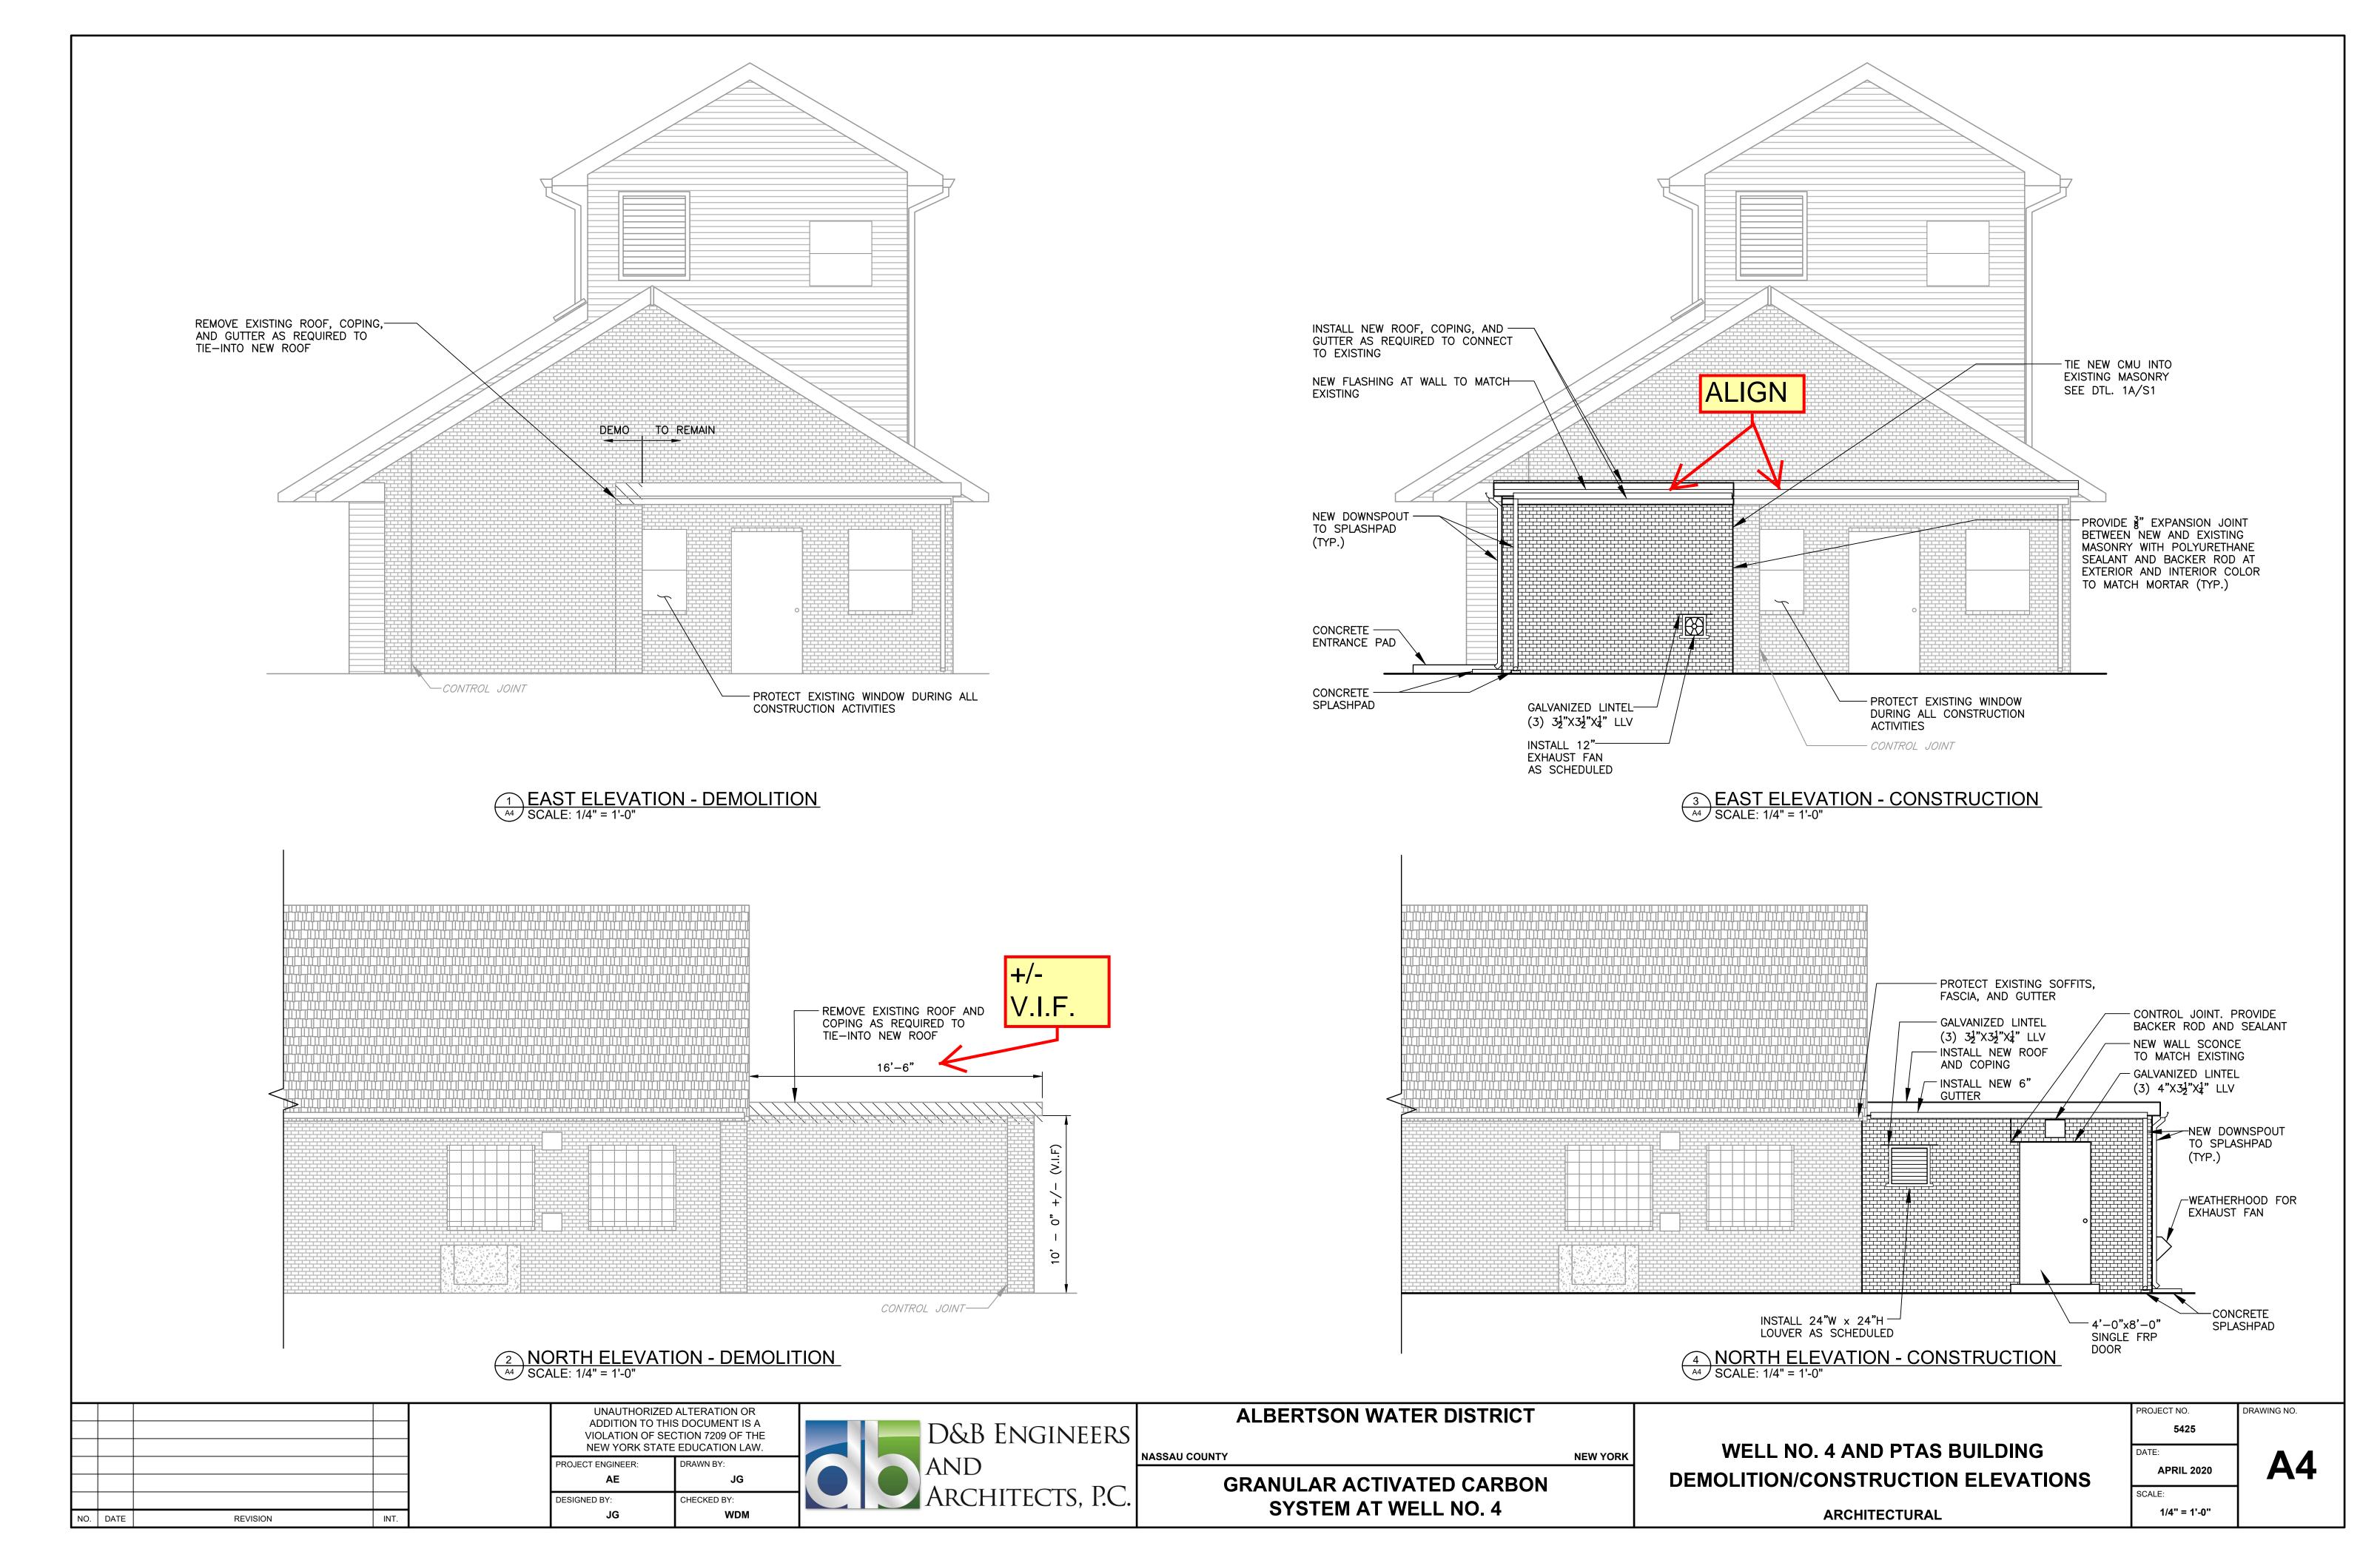E-15425-AWD CAC-WELL A/Aww/serch5425 A3 - WELL NO 4 AND DTAS BLILLDING ELOOP DEAN AWA A3 4/22/2020 7:48:30 DM Abrenta







# TYPICAL DOOR AND FRAME MATERIALS:

HM = HOLLOW METAL WD = WOOD

G = GLASS

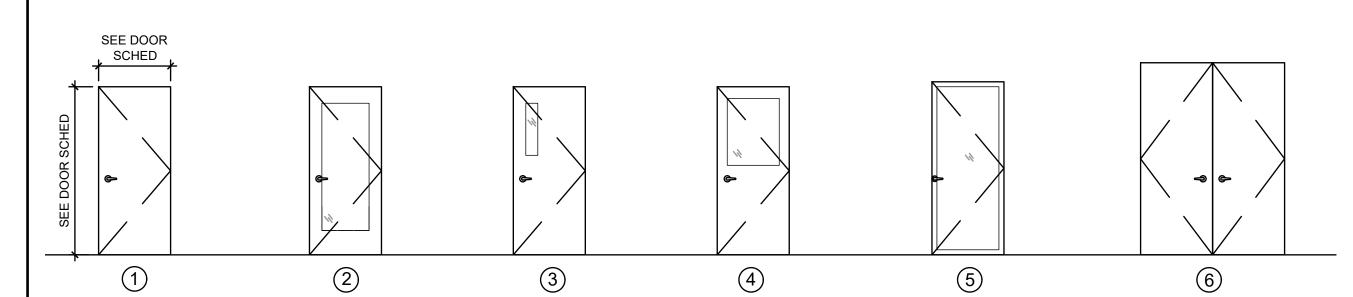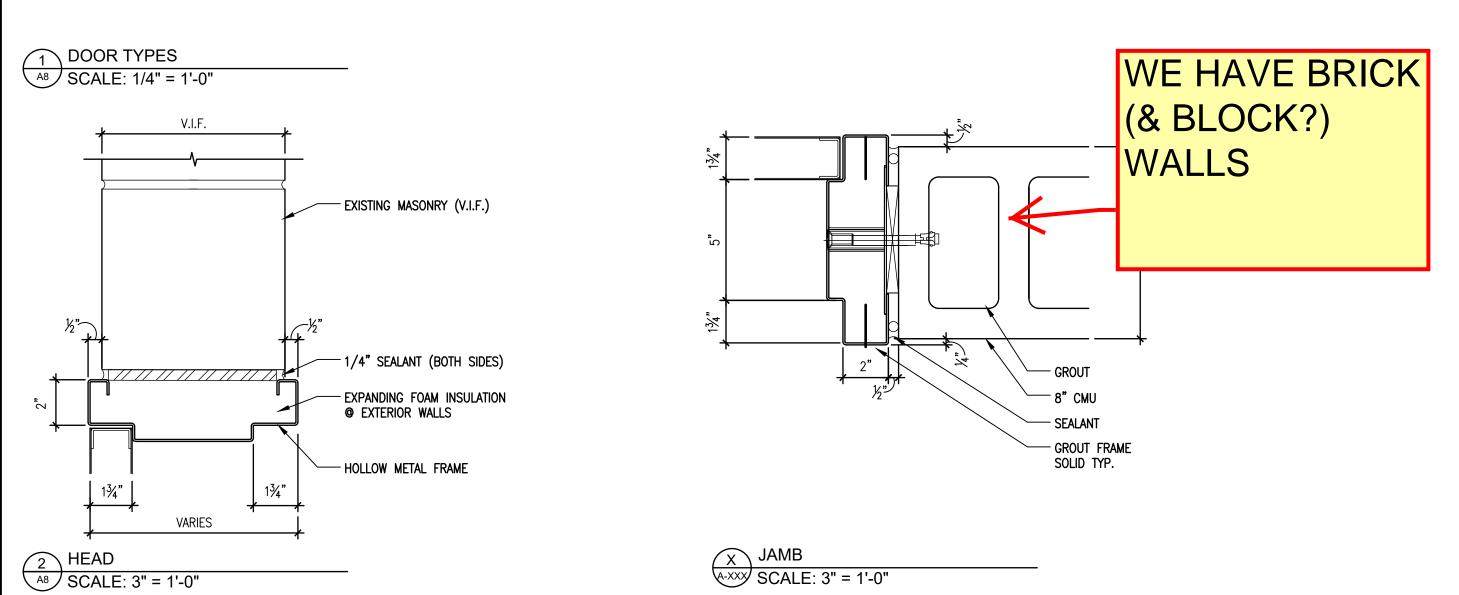NOTES: ALL EXTERIOR DOORS TO BE INSULATED. FIELD VERIFY EXISTING SIZES FOR DOORS THAT ARE TO BE REPLACED.





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**UNAUTHORIZED ALTERATION OR** ADDITION TO THIS DOCUMENT IS A

VIOLATION OF SECTION 7209 OF THE NEW YORK STATE EDUCATION LAW.


CHECKED BY:

HARDWARE SETS:				
	QTY:	MODEL	BRAND	NOTES:
HARDWARE SET 1:				
PUSH/PULL				
HINGE:				
CLOSER:				
SADDLE:				
WEATHERSTRIPPING:				
KICKPLATE:				
HARDWARE SET 2:				
PUSH/PULL				
HINGE:				
CLOSER:				
SADDLE:				
WEATHERSTRIPPING:				
KICKPLATE:				

POST MOUNT SERIES

HARDWARE SET 1:

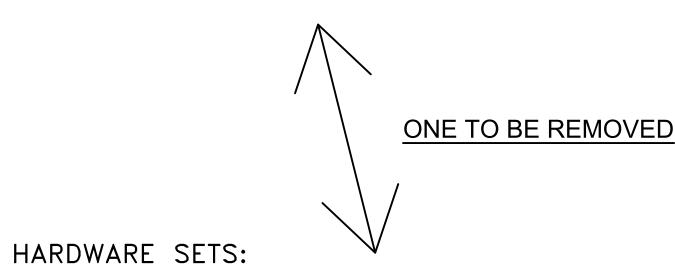PUSH/PULL:



ROCKWOOD LOCKING PUSH/PULL

## **GENERAL NOTES:**

- 1. ALL DOORS SHALL BE FIELD VERIFIED PRIOR TO OPENING 2. ALL DOORS SHALL MATCH EXISTING SIZE, COLOR, AND STYLE,
- UNLESS NOTED OTHERWISE.
- 3. ALL DOORS SHALL BE INSTALLED AS PER MANUFACTURER'S RECOMMENDATIONS. CONTRACTOR TO VERIFY ALL CONDITIONS IN FIELD. ANY DISCREPANCIES FROM WHAT IS INDICATED ON THE
- CONTRACT DOCUMENTS ARE TO BE BROUGHT TO THE ARCHITECT OF RECORD'S ATTENTION. EXISTING CONDITIONS ARE TO BE INDICATED ON SHOP DRAWING SUBMITTALS. 4. ALL HM FRAMES TO BE 16 GA. ALL EXTERIOR HM FRAMES TO BE FULLY WELDED AND HOT DIP GALVANIZED. ALL INTERIOR HM
- FRAMES MAY BE KNOCK DOWN RO WELDED FRAMES. 5. EXTERIOR HM DOORS TO BE 18 GA. FULLY WELDED AND HOT DIP

9. HARDWARE TRIM HEIGHT SHALL BE PER ICC/ANSI A117.1-2009.

- GALVANIZED WITH CLOSED TOP.
- 6. KEY LOCKS IN COORDINATION WITH OWNER'S KEYING & MASTER KEY SYSTEMS.
- 7. VERIFY ALL HARDWARE WITH OWNER BEFORE ORDERING.
- 8. PROVIDE 3 DOOR SILENCERS PER JAMB.

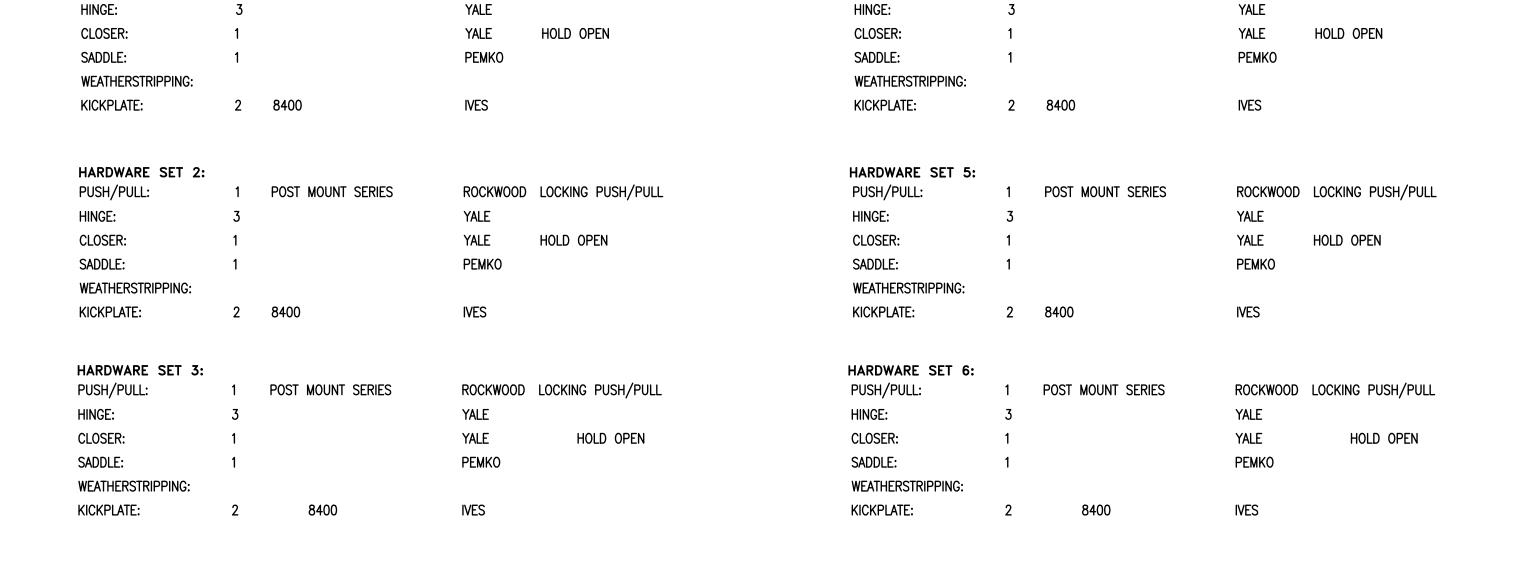
## DOOR/ HARDWARE NOTES:

- 1. REINSTALLED HARDWARE TO MATCH FUNCTION / COMPONENTS CALLED FOR IN HARDWARE SCHEDULE. COORDINATE ANY PROPOSED CHANGES WITH OWNER U.O.N.
- 2. ALL INTERIOR HINGES TO BE 1-1/2 PAIR, U.O.N. 3. ALL SADDLES TO BE ADA COMPLIANT. BATHROOM SADDLES TO

ROCKWOOD LOCKING PUSH/PULL


- BE STONE.
- 4. ALL INTERIOR DOORS TO HAVE SILENCERS.

POST MOUNT SERIES



HARDWARE SET 4:

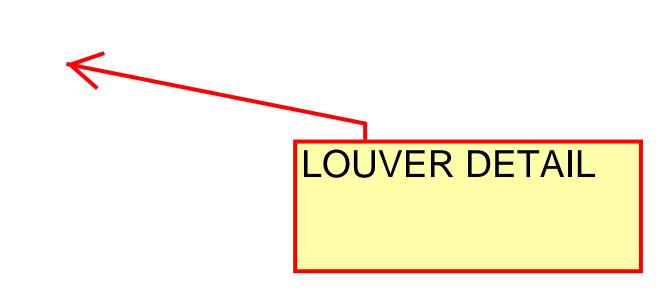PUSH/PULL:



D&B ENGINEERS

AND ARCHITECTS, P.C.

**ALBERTSON WATER DISTRICT** NASSAU COUNTY **NEW YORK** 

> **GRANULAR ACTIVATED CARBON SYSTEM AT WELL NO. 4**

**WELL NO. 4 AND PTAS BUILDING Door & Window Schedules & Details** 

CONTRACT NO.

ROJECT NO. 5425 **APRIL 2020** SCALE:

1"=10'

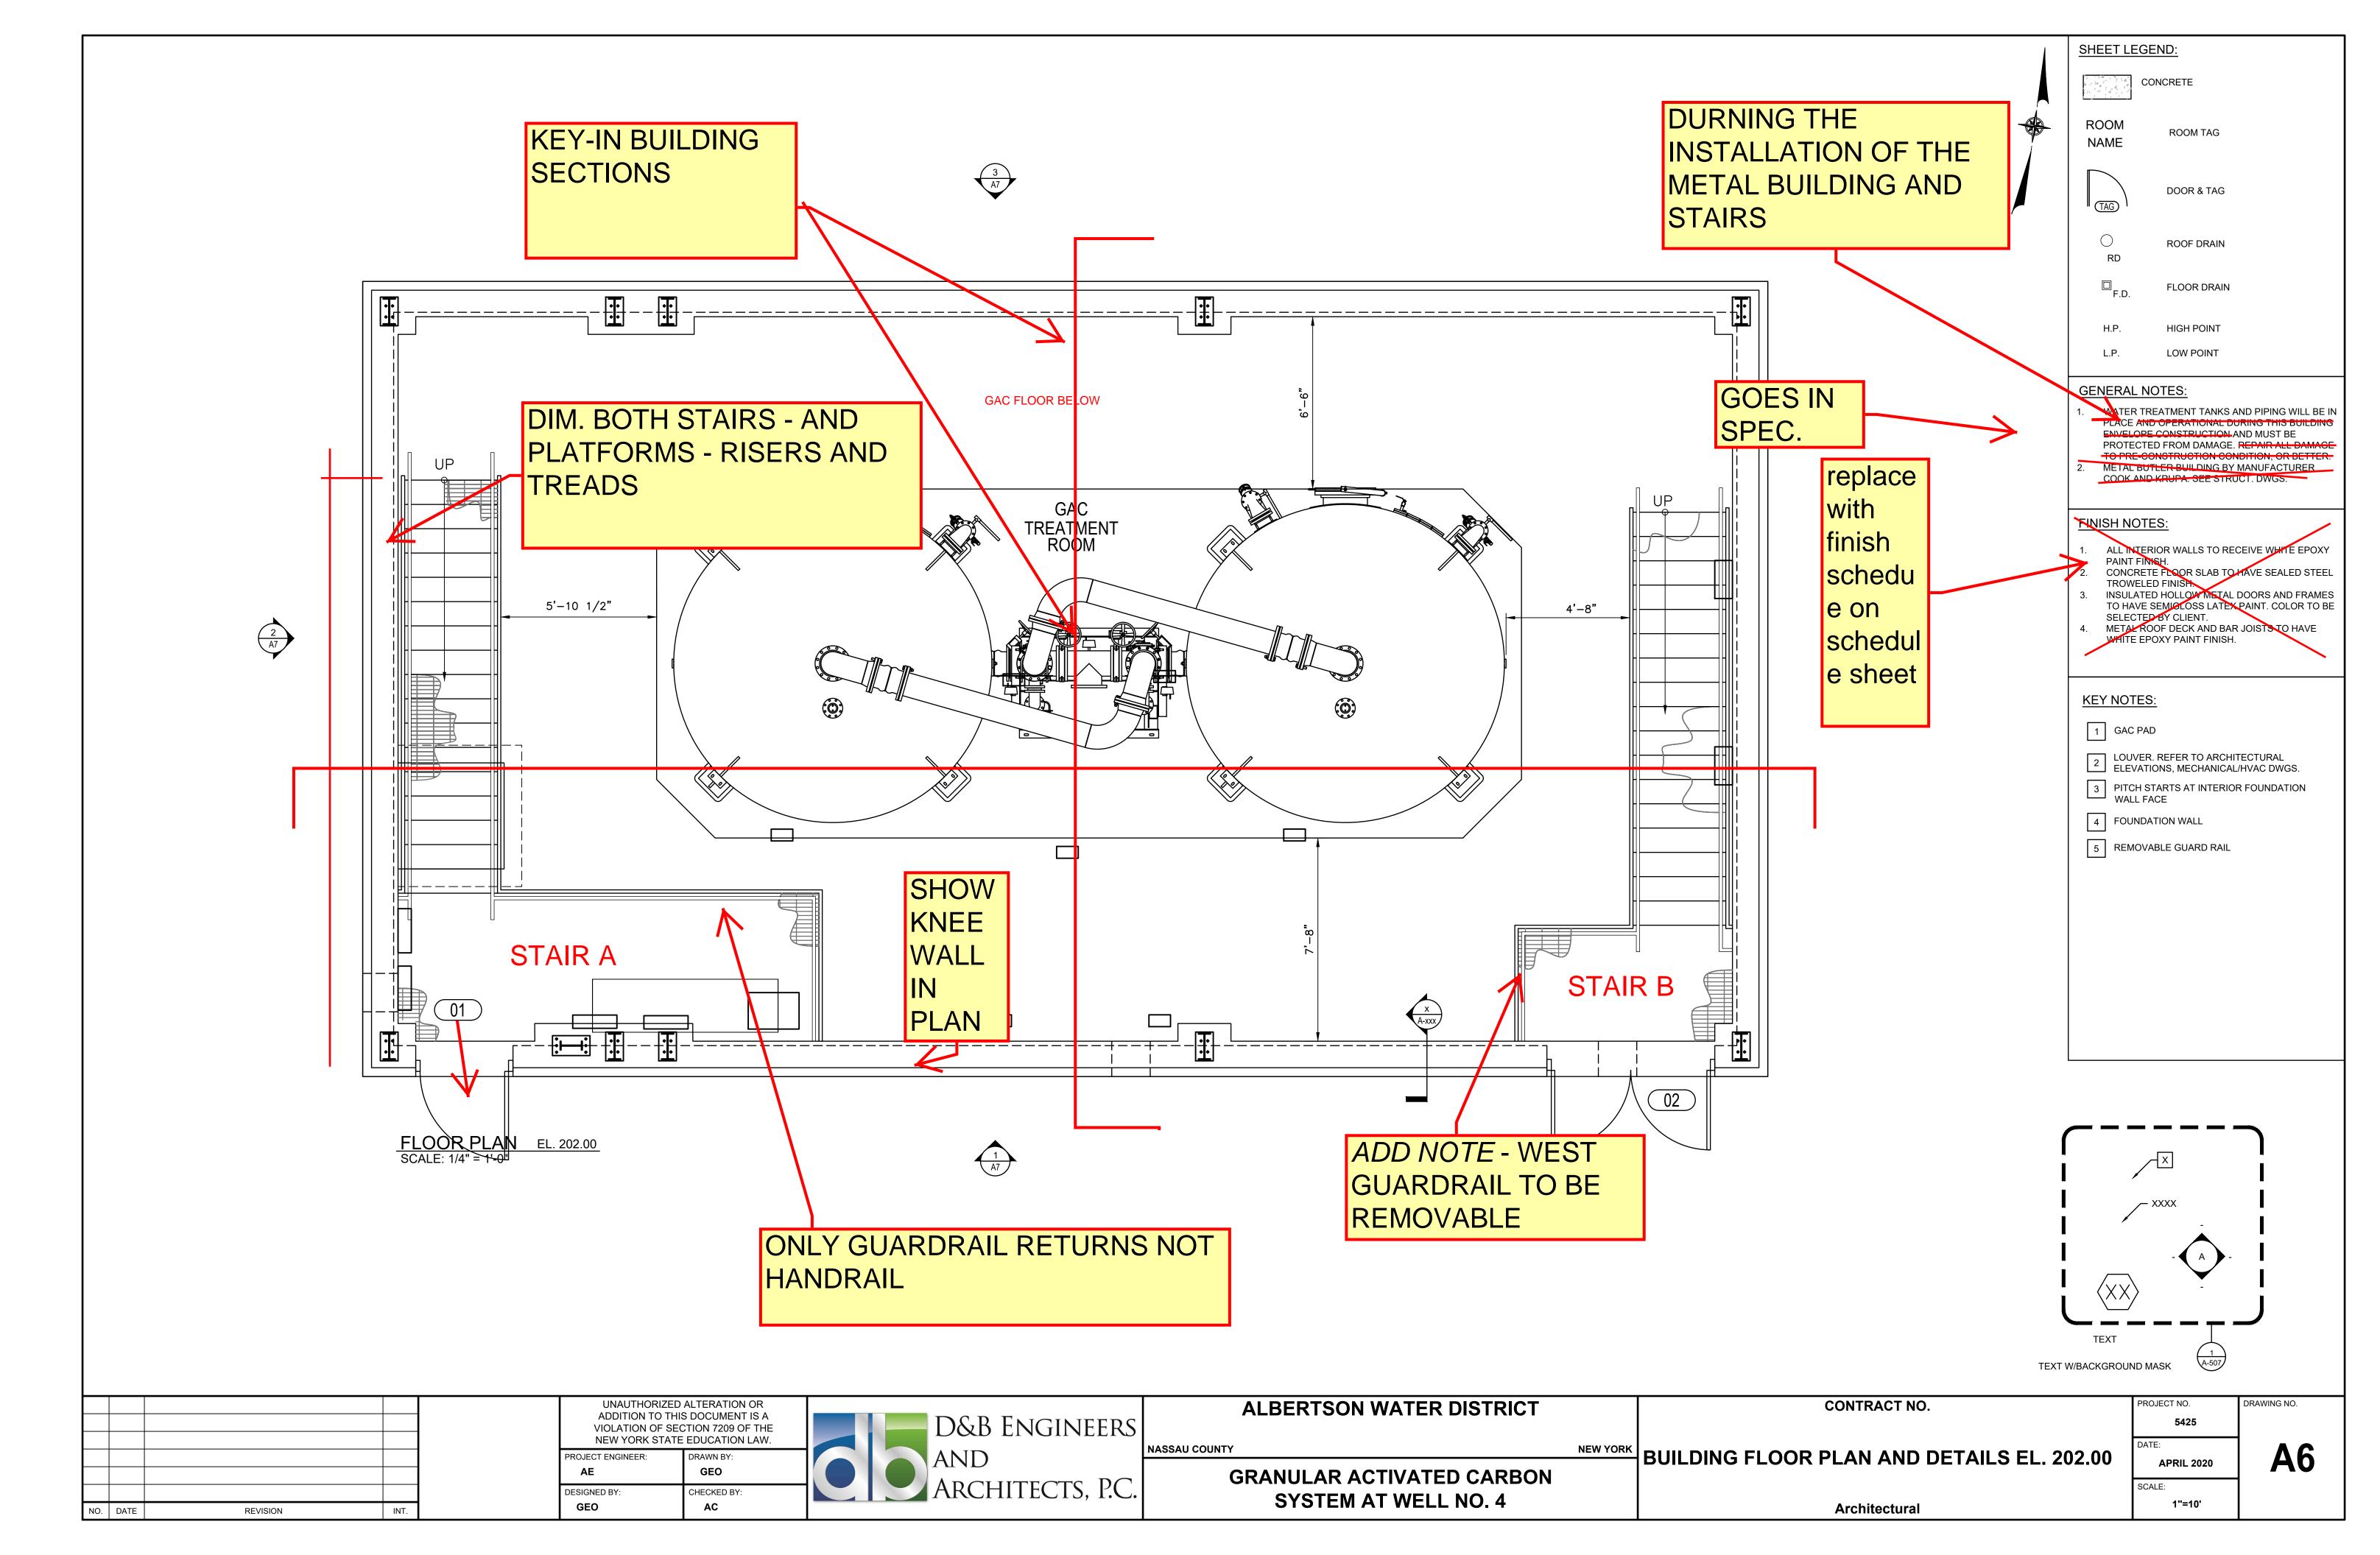
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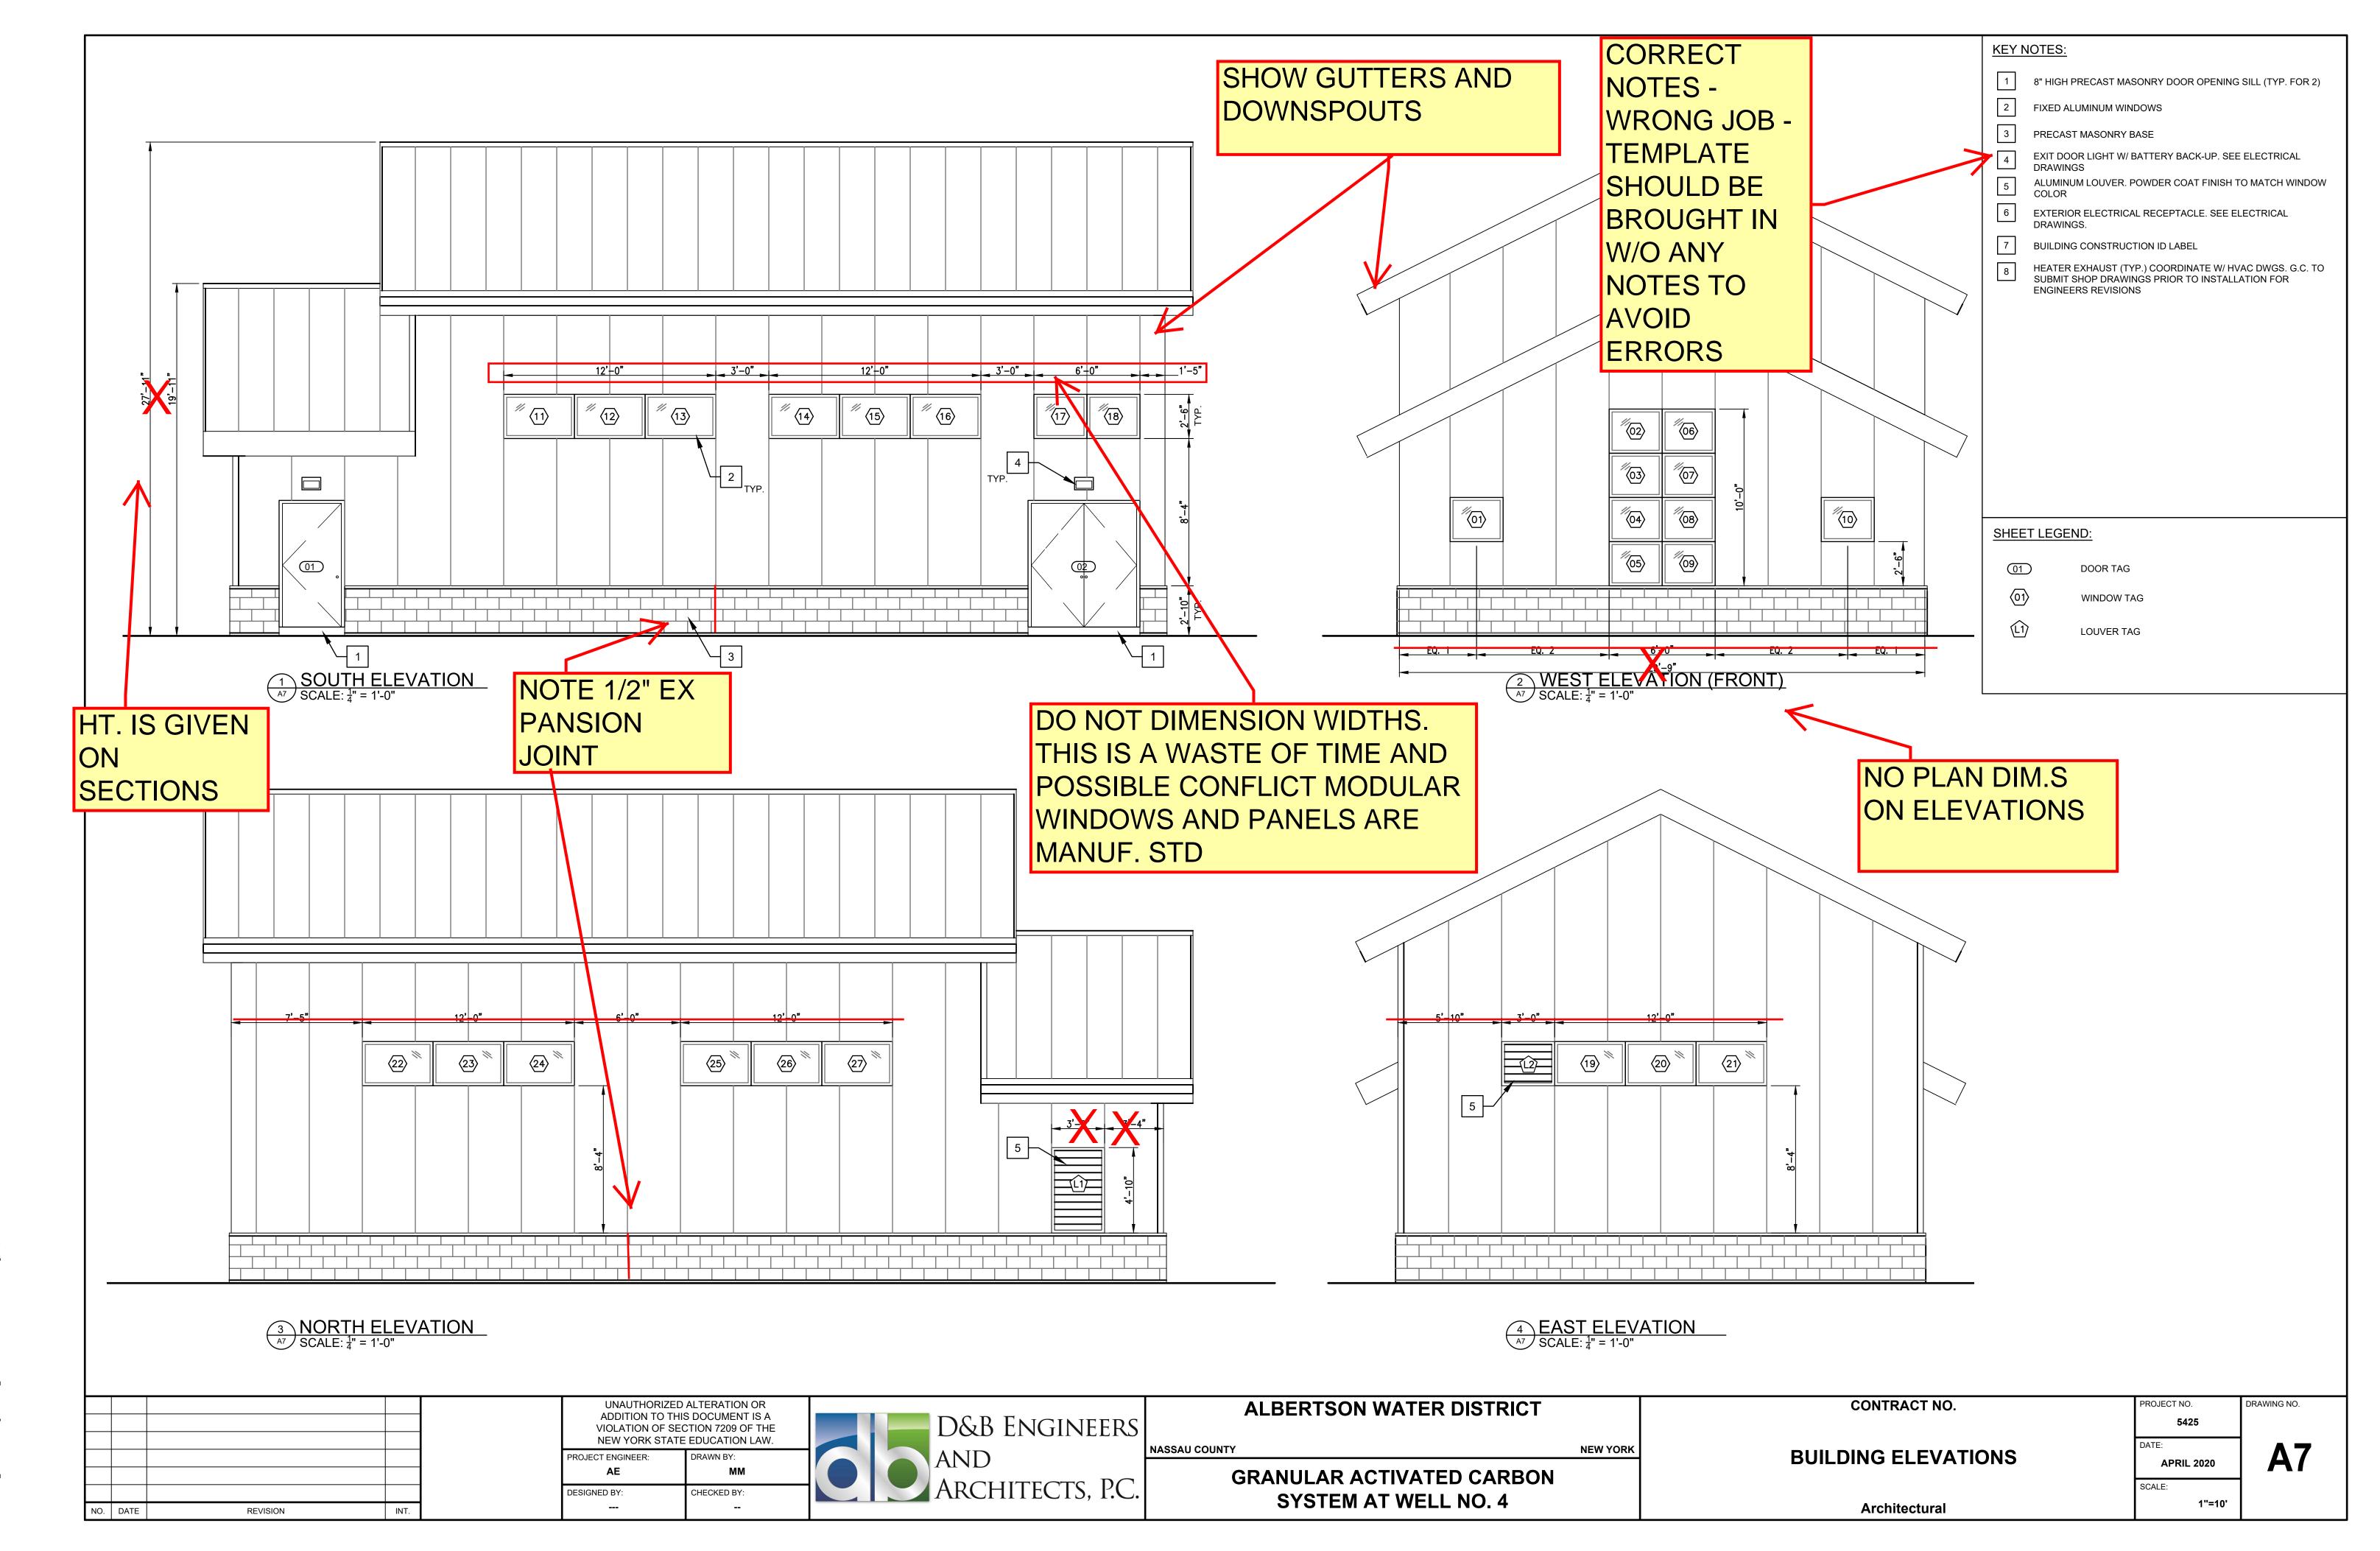
**Architectural** 

NO. DATE


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F:\5425-AWD\_GAC-WELL 4\dwg\arch\5425\_A6 - GAC BUILDING FLOOR PLAN AND DETAILS EL. 202.00.dwg, A6, 4/22/2020 7:43:58 PM



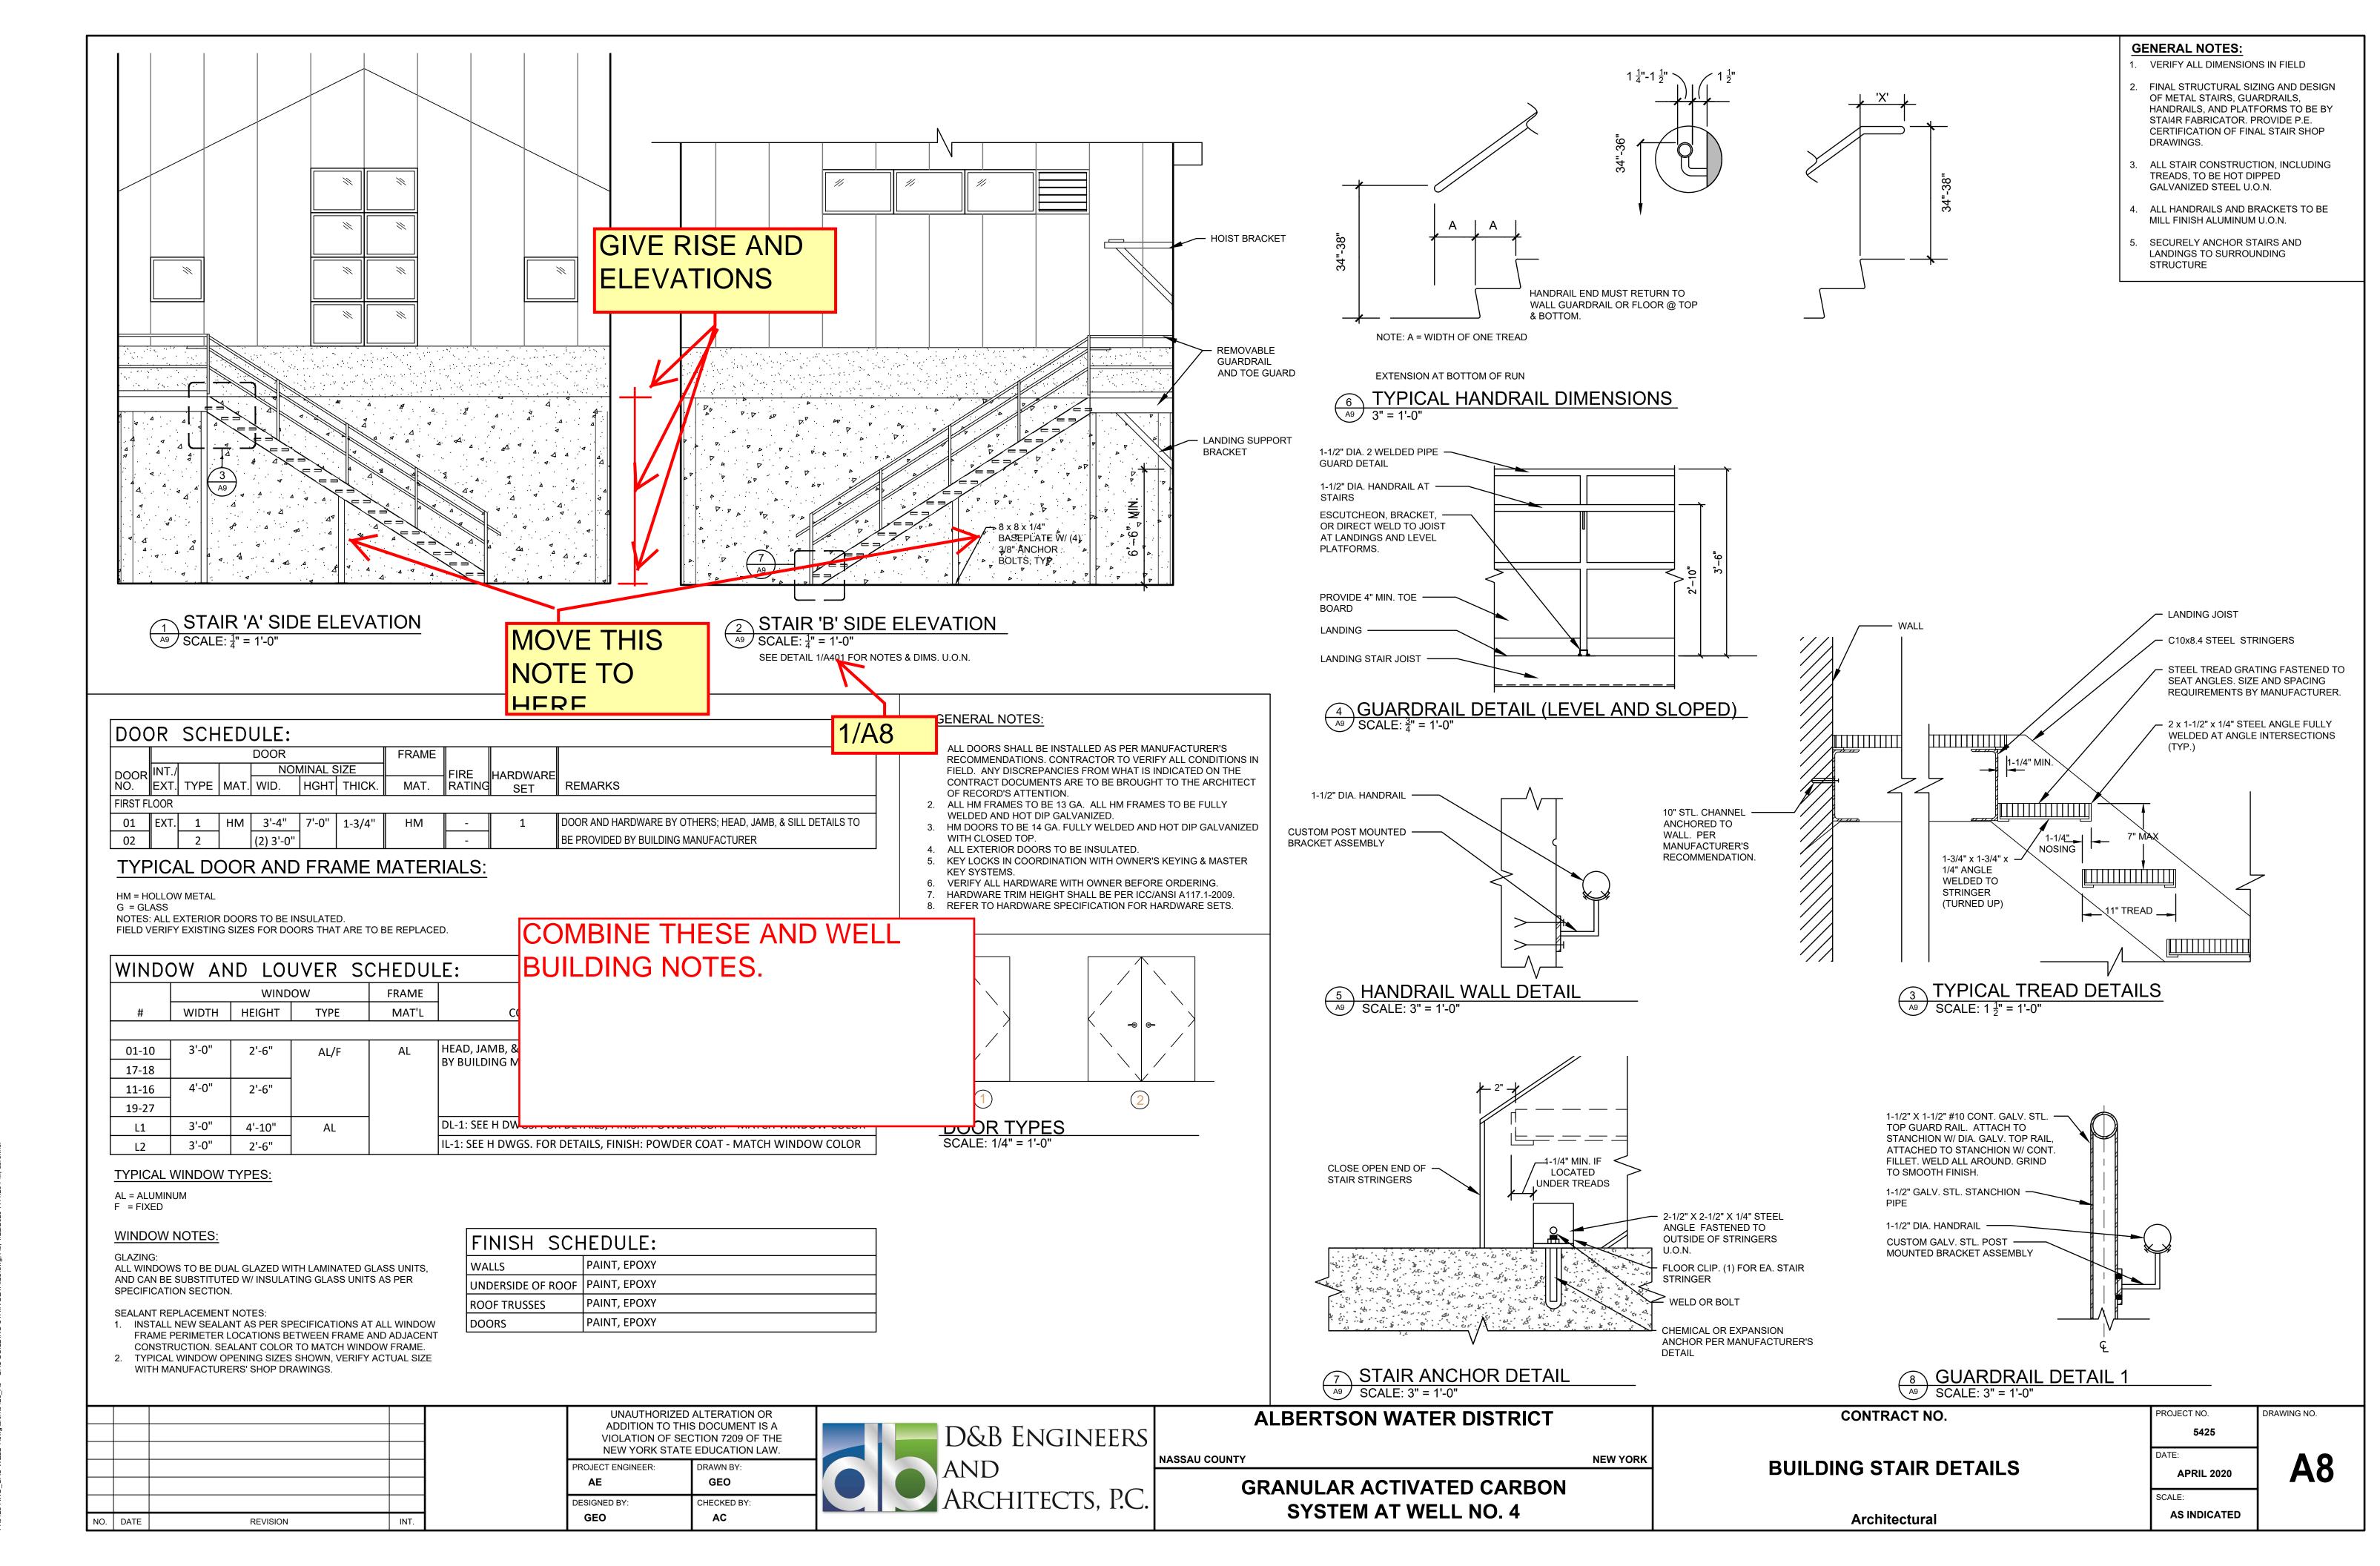F:\5425-AWD GAC-WELL 4\dwq\arch\5425 A7 - GAC BUILDING ELEVATIONS.dwq, A7, 4/22/2020 7:44:18 PM, dbrenn



F-\5425-AWD GAC-WELL 4\dwg\arch\5425 A9 - GAC BUILDING STAIR DETAILS dwg A9 4/22/2020 7:44-20 PM